#### STANDARD ENGINEERING NOTES

- 1. THESE PLANS ARE SUBJECT TO THE INTERPRETATION OF INTENT BY THE ENGINEER. ALL QUESTIONS REGARDING THESE PLANS SHALL BE PRESENTED TO THE ENGINEER. ANYONE WHO TAKES IT UPON THEMSELVES THE INTERPRETATION OF THE DRAWINGS OR MAKES REVISIONS TO THE SAME WITHOUT CONFERRING WITH THE DESIGN ENGINEER SHALL BE RESPONSIBLE FOR THE CONSEQUENCES THEREOF.
- 2. PRIOR TO BIDDING THE WORK, THE CONTRACTOR SHALL THOROUGHLY SATISFY HIMSELF AS TO THE ACTUAL CONDITIONS, REQUIREMENTS OF THE WORK AND EXCESS OR DEFICIENCY IN QUANTITIES. NO CLAIMS SHALL BE MADE AGAINST THE OWNER/DEVELOPER OR ENGINEER FOR ANY EXCESS OR DEFICIENCY THEREIN, ACTUAL OR RELATIVE.
- 3. THE ENGINEER SHALL NOT BE RESPONSIBLE FOR CONSTRUCTION MEANS, METHODS, TECHNIQUES, SEQUENCES, PROCEDURES OR SAFETY PRECAUTIONS OR PROGRAMS UTILIZED IN CONNECTION WITH THE WORK, AND WILL NOT BE RESPONSIBLE FOR THE CONTRACTOR'S FAILURE TO CARRY OUT THE WORK IN ACCORDANCE WITH THE CONTRACT DOCUMENTS.
- 4. THE ENGINEER SHALL NOT BE RESPONSIBLE FOR COORDINATING THE RELOCATION OF UTILITIES, LIGHTS, IRRIGATION ETC.
- 5. THE CONTRACTOR IS TO VERIFY THE LOCATION, ELEVATION, CONDITION, AND PAVEMENT CROSS—SLOPE OF ALL EXISTING SURFACES AT POINTS OF TIE—IN AND MATCHING, PRIOR TO COMMENCEMENT OF CONSTRUCTION. SHOULD EXISTING LOCATIONS, ELEVATIONS, CONDITION, OR PAVEMENT CONFLICT WITH ADA OR FIH PLAYING FIELD REQUIREMENTS, THE CONTRACTOR SHALL NOTIFY THE OWNER'S AGENT IMMEDIATELY FOR DIRECTION ON HOW TO PROCEED PRIOR TO COMMENCEMENT OF CONSTRUCTION. THE CONTRACTOR ACCEPTS RESPONSIBILITY FOR ALL COSTS ASSOCIATED WITH CORRECTIVE ACTION IF THESE PROCEDURES ARE NOT FOLLOWED.
- 6. EXISTING UTILITIES ARE NOT SHOWN. CALL UNDERGROUND SERVICE ALERT PRIOR TO CONSTRUCTION. THE COLLEGE CAN BE COORDINATED WITH TO MARK KNOWN UTILITIES BELONGING TO THE COLLEGE. THE CONTRACTOR SHALL PROTECT AND MAINTAIN ALL EXISTING UTILITIES ON THE SITE. ANY DAMAGE TO EXISTING UTILITIES, WHETHER SHOWN OR NOT ON THE DRAWING, SHALL BE REPAIRED/REPLACED AT THE CONTRACTOR'S EXPENSE. EXISTING SURFACE FEATURES AND FENCING SHALL BE REPLACED IN KIND.
- 7. THE ENGINEER AND APPLICABLE AGENCY MUST APPROVE, PRIOR TO CONSTRUCTION, ANY ALTERATION, OR VARIANCE FROM THESE PLANS. ANY VARIATIONS FROM THESE PLANS SHALL BE PROPOSED ON CONSTRUCTION FIELD PRINTS AND TRANSMITTED TO THE ENGINEER.
- 8. ANY INSPECTION BY ANY JURISDICTIONAL AGENCY, SHALL NOT, IN ANY WAY, RELIEVE THE CONTRACTOR FROM ANY OBLIGATION TO PERFORM THE WORK IN STRICT COMPLIANCE WITH APPLICABLE CODES AND AGENCY REQUIREMENTS.
- 9. ANY HAULING PERMITS REQUIRED ARE TO BE OBTAINED BY THE CONTRACTOR AT NO ADDITIONAL COST TO THE OWNER.
- 10. ANY CONSTRUCTION WATER ACCESS IS TO BE OBTAINED BY THE CONTRACTOR AT NO ADDITION COST TO THE OWNER. FIRE HYDRANT ACCESS MUST BE PERMITTED AND METERED BY THE COUNTY WATER DISTRICT 1 AT NO ADDITIONAL COST TO THE OWNER.
- 11. CONTRACTOR IS RESPONSIBLE FOR PROTECTING ALL STORM DRAIN PIPES AND DRAINAGE FACILITIES FROM DAMAGE DURING ALL STAGES OF CONSTRUCTION.

#### PARTIAL LIST OF APPLICABLE CODES AS OF JANUARY 1, 2017

- 2016 CALIFORNIA ADMINISTRATIVE CODE, PART 1, TITLE 24 C.C.R. 2016 CALIFORNIA BUILDING CODE (CBC), PART 2, TITLE 24 C.C.R.
- 2016 CALIFORNIA ELECTRICAL CODE (CEC), PART 3, TITLE 24 C.C.R.
- 2016 CALIFORNIA FIRE CODE, PART 9, TITLE 24 C.C.R.
- 2016 CALIFORNIA GREEN BUILDING STANDARDS CODE, PART 11, TITLE 24 C.C.R.
- 2016 CALIFORNIA REFERENCE STANDARDS, PART 12, TITLE 24 C.C.R. TITLE 19 C.C.R., PUBLIC SAFETY, STATE FIRE MARSHALL REGULATIONS
- 2018 ADA STANDARDS FOR ACCESSIBLE DESIGN

#### NOTES

1. SOME CODES MAY NOT APPLY IF WORK REGULATED BY SUCH CODE IS NOT WITHIN THE SCOPE OF THIS PROJECT.


# BEFORE YOU OF SOON OF

Section 4216/4217 of the government code requires a dig alert identification number be issued before a "permit to excavate" will be valid.

Call (2) working days before you dig.

# FOOTHILL HIGH SCHOOL ATHLETIC FIELDS

# EAST SIDE UNION HIGH SCHOOL DISTRICT

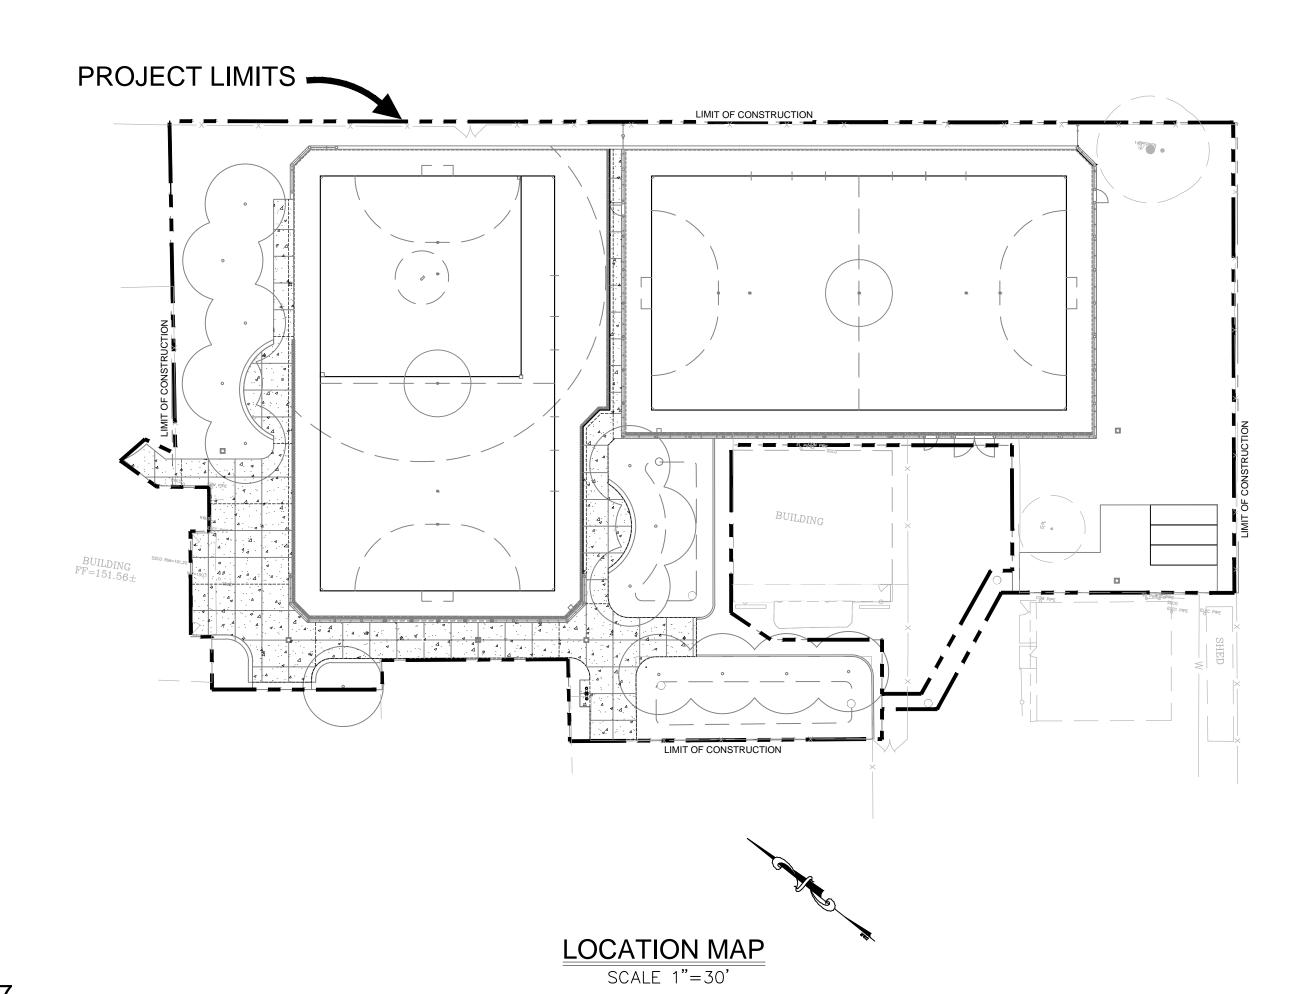


#### SCOPE OF WORK

THE PROJECT SCOPE OF WORK INCLUDES CONSTRUCTION OF SYNTHETIC TURF FIELDS, FENCING, PAVING AND LANDSCAPING. PAVEMENT RENOVATIONS TO PROVIDE DSA COMPLIANT PATHWAYS.

#### **BENCHMARK**

THE LETTER "I" IN THE WORD IRON ON TOP OF THE CATCH BASIN, WEST SIDE OF WHITE ROAD AT ANGLE POINT IN THE ROAD, APPROXIMATELY 600 FEET NORTH OF HYLAND AVENUE, 25 FEET NORTH OF SCHOOL BUS ENTRANCE TO JAMES LICK HIGH SCHOOL. F.B. 778, PAGE 71. BENCHMARK ID 82. REFERENCE MARK-247-D. ELEVATION 158.12

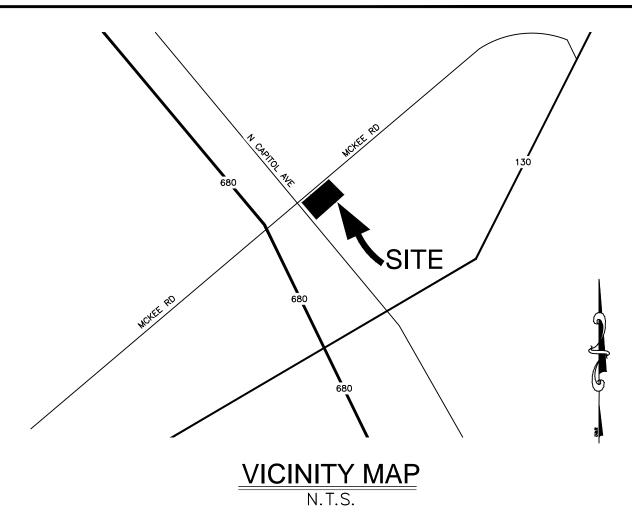

#### SHEET INDEX

PF-00 COVER SHEET PF-01 OVERALL SITE AND ACCESS PLAN PF-02 DEMOLITION PLAN PF-03 SURFACING PLAN PF-04 GRADING PLAN PF-05 DRAINAGE PLAN PF-06 DIMENSION PLAN TURF GRAPHICS PLAN PF-08 IRRIGATION PLAN PF-09 PLANTING PLAN PF-10.1 DETAILS PF-10.2 DETAILS PF-10.3 DETAILS PF-10.4 DETAILS PF-10.5 DETAILS PF-10.6 DETAILS

#### **OWNER**

EAST SIDE UNION HIGH SCHOOL DISTRICT JULIO LUCAS, DIRECTOR OF FACILITIES 830 N. CAPITOL AVE SAN JOSE, CA 95133 PH: (408) 239-9647

#### **ENGINEER**

ANTHONY STEVENSON
LLOYD CIVIL AND SPORTS ENGINEERING, LLC
7349 N. VIA PASEO DEL SUR
SUITE 515-324
SCOTTSDALE, AZ 85258
(602) 635-4226
EMAIL: astevenson@lloydengineers.com

#### LANDSCAPE ARCHITECT

BRETT LONG
LLOYD CIVIL AND SPORTS ENGINEERING, LLC
7349 N. VIA PASEO DEL SUR
SUITE 515-324
SCOTTSDALE, AZ 85258
(408) 338-6048
EMAIL: blong@lloydengineers.com



SUITE 515-324

SCOTTSDALE, ARIZONA 85258

PH 602.635.4226

FAX 602.997.3148

IDENTIFICATION STAMP
DIV. OF THE STATE ARCHITECT
OFFICE OF REGULATION SERVICES

01-117698

DATE

FLS SS

DSA BACK CHECK

FOOTHILL HIGH SCHOOL ATHLETIC FIELDS 230 PALA AVENUE

San Jose, CA

SCALE: AS NOTED

DESIGNED: BTL


DATE: 11/06/2018

DRAWN: TML

PROJ. 18-115
APPROVED:

**COVER** 

DWG. NO.

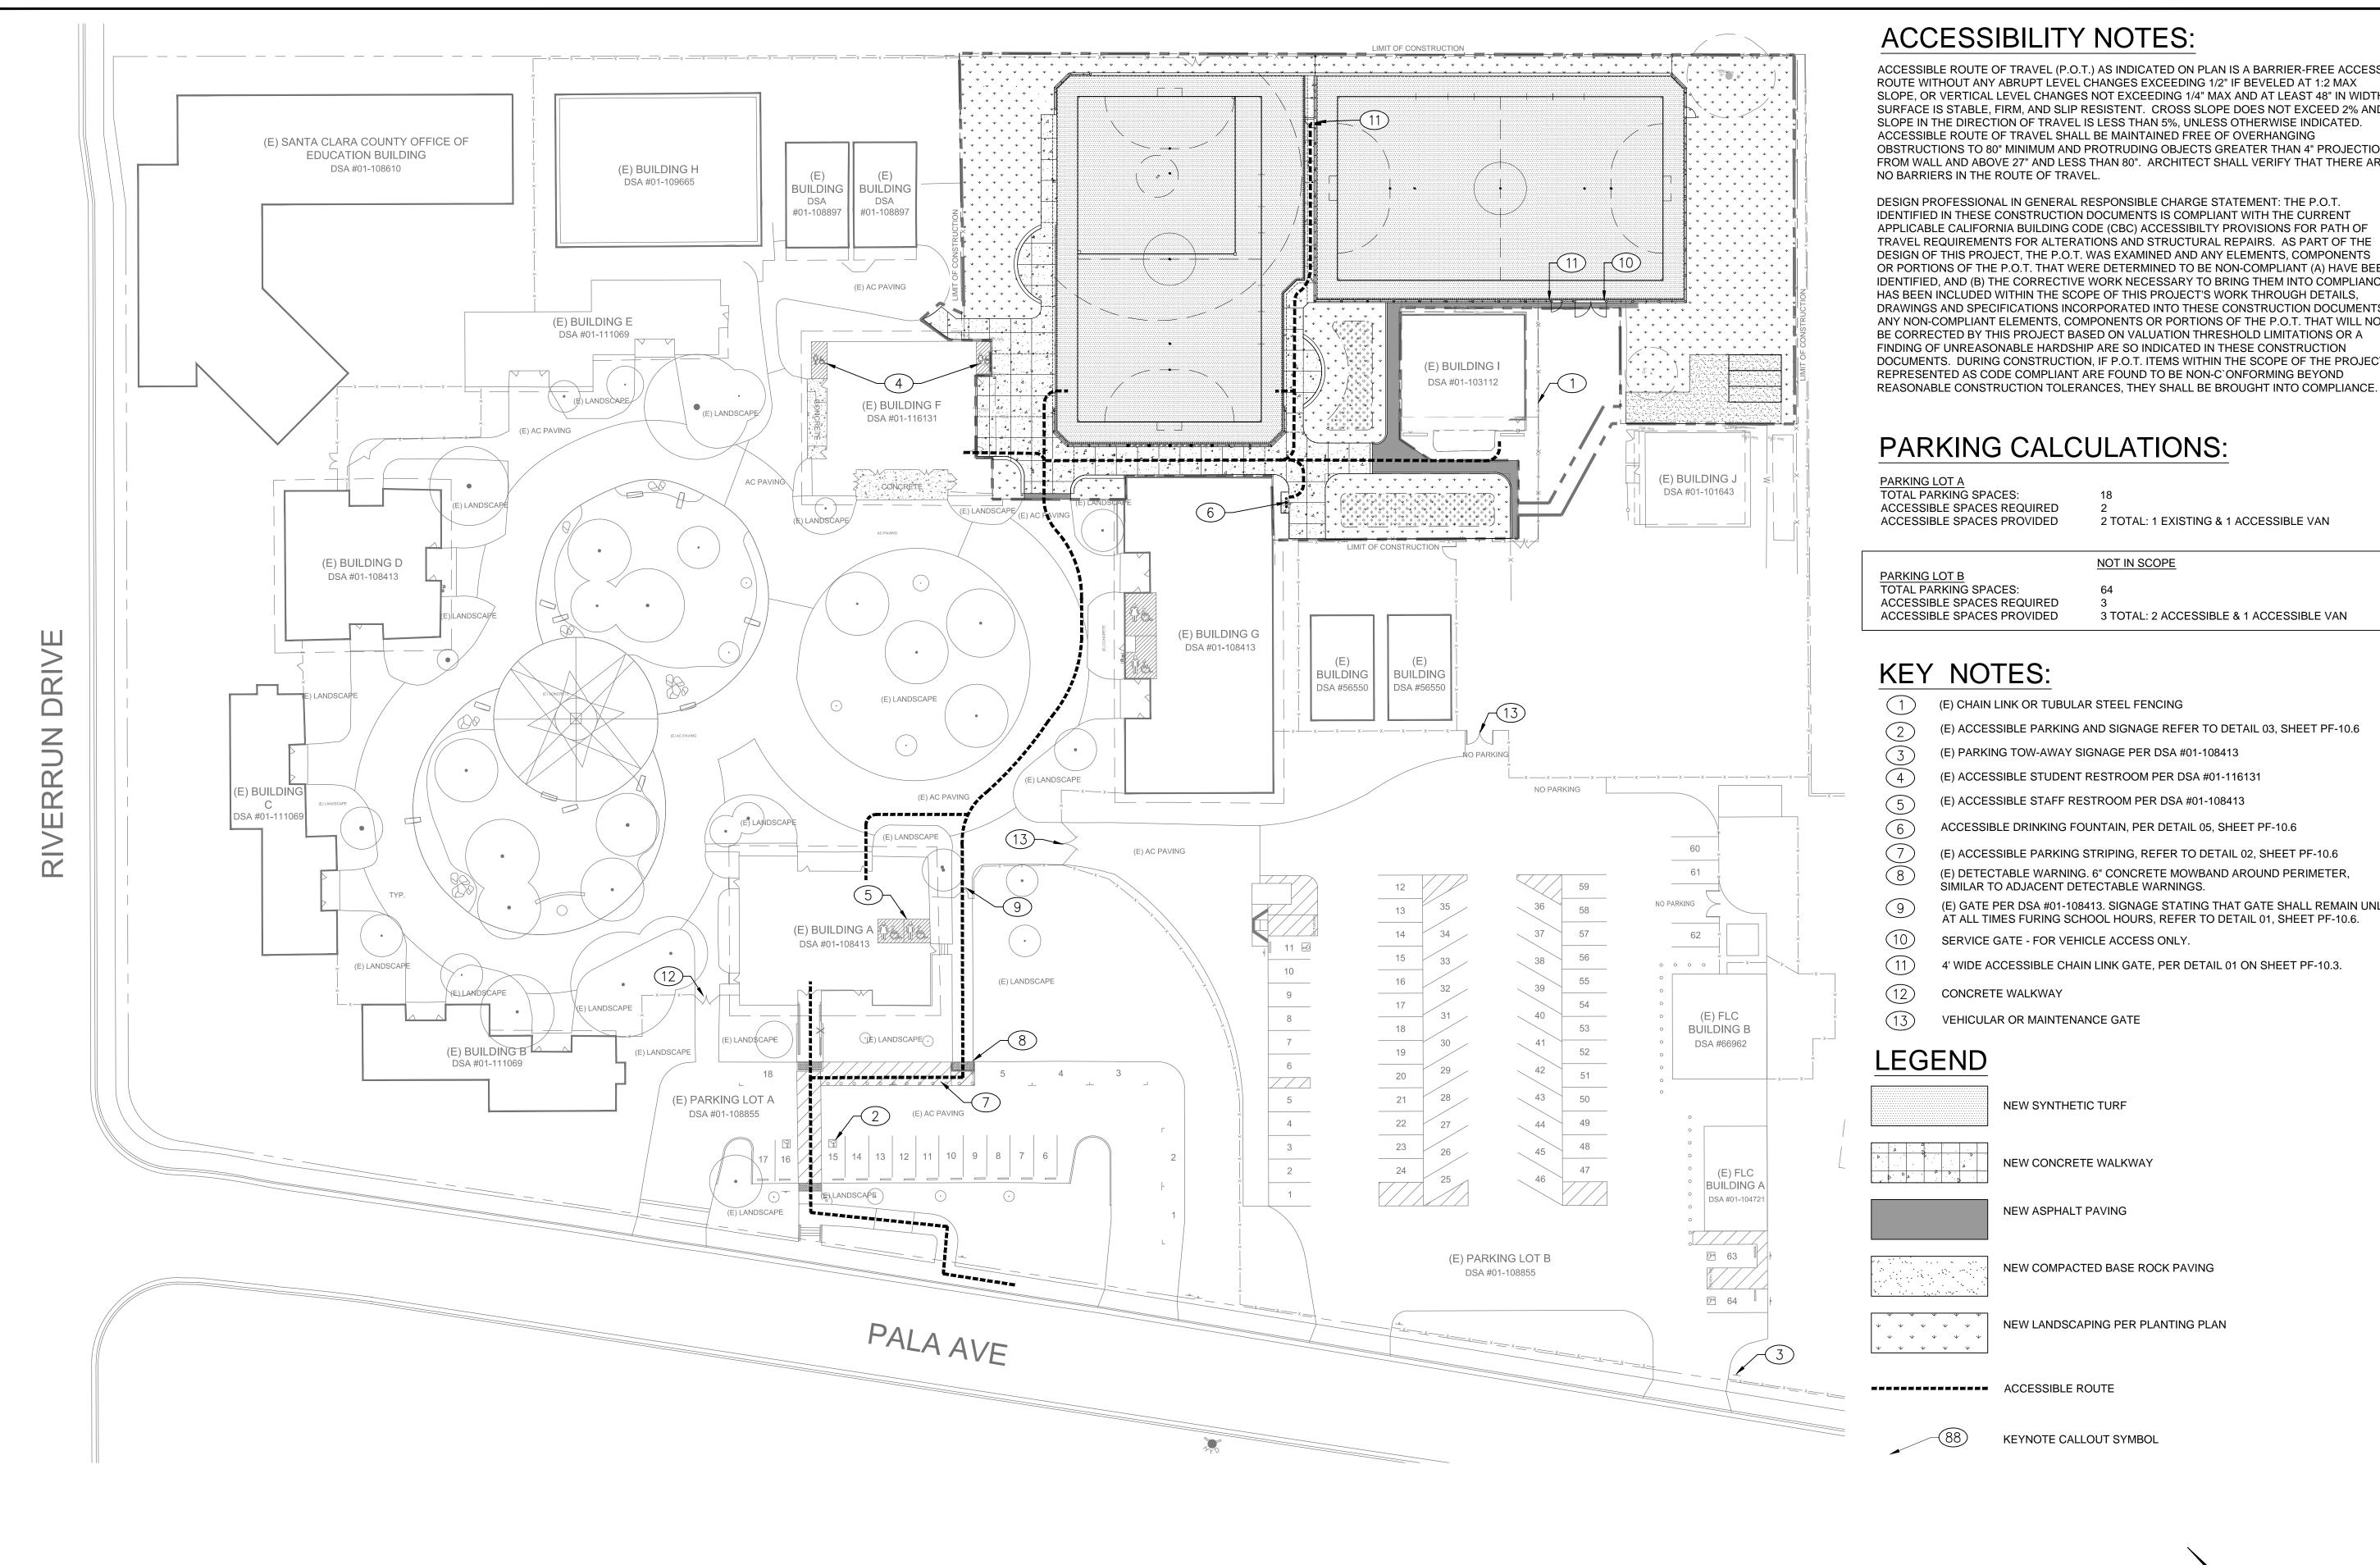



ACCESSIBLE ROUTE OF TRAVEL (P.O.T.) AS INDICATED ON PLAN IS A BARRIER-FREE ACCESS ROUTE WITHOUT ANY ABRUPT LEVEL CHANGES EXCEEDING 1/2" IF BEVELED AT 1:2 MAX SLOPE, OR VERTICAL LEVEL CHANGES NOT EXCEEDING 1/4" MAX AND AT LEAST 48" IN WIDTH. SURFACE IS STABLE, FIRM, AND SLIP RESISTENT. CROSS SLOPE DOES NOT EXCEED 2% AND SLOPE IN THE DIRECTION OF TRAVEL IS LESS THAN 5%, UNLESS OTHERWISE INDICATED. ACCESSIBLE ROUTE OF TRAVEL SHALL BE MAINTAINED FREE OF OVERHANGING OBSTRUCTIONS TO 80" MINIMUM AND PROTRUDING OBJECTS GREATER THAN 4" PROJECTION FROM WALL AND ABOVE 27" AND LESS THAN 80". ARCHITECT SHALL VERIFY THAT THERE ARE NO BARRIERS IN THE ROUTE OF TRAVEL.

DESIGN PROFESSIONAL IN GENERAL RESPONSIBLE CHARGE STATEMENT: THE P.O.T. IDENTIFIED IN THESE CONSTRUCTION DOCUMENTS IS COMPLIANT WITH THE CURRENT APPLICABLE CALIFORNIA BUILDING CODE (CBC) ACCESSIBILTY PROVISIONS FOR PATH OF TRAVEL REQUIREMENTS FOR ALTERATIONS AND STRUCTURAL REPAIRS. AS PART OF THE DESIGN OF THIS PROJECT, THE P.O.T. WAS EXAMINED AND ANY ELEMENTS, COMPONENTS OR PORTIONS OF THE P.O.T. THAT WERE DETERMINED TO BE NON-COMPLIANT (A) HAVE BEEN IDENTIFIED, AND (B) THE CORRECTIVE WORK NECESSARY TO BRING THEM INTO COMPLIANCE HAS BEEN INCLUDED WITHIN THE SCOPE OF THIS PROJECT'S WORK THROUGH DETAILS, DRAWINGS AND SPECIFICATIONS INCORPORATED INTO THESE CONSTRUCTION DOCUMENTS. ANY NON-COMPLIANT ELEMENTS, COMPONENTS OR PORTIONS OF THE P.O.T. THAT WILL NOT BE CORRECTED BY THIS PROJECT BASED ON VALUATION THRESHOLD LIMITATIONS OR A FINDING OF UNREASONABLE HARDSHIP ARE SO INDICATED IN THESE CONSTRUCTION DOCUMENTS. DURING CONSTRUCTION, IF P.O.T. ITEMS WITHIN THE SCOPE OF THE PROJECT REPRESENTED AS CODE COMPLIANT ARE FOUND TO BE NON-C'ONFORMING BEYOND

#### PARKING CALCULATIONS:

PARKING LOT A TOTAL PARKING SPACES: ACCESSIBLE SPACES REQUIRED ACCESSIBLE SPACES PROVIDED

2 TOTAL: 1 EXISTING & 1 ACCESSIBLE VAN

NOT IN SCOPE PARKING LOT B TOTAL PARKING SPACES: ACCESSIBLE SPACES REQUIRED

3 TOTAL: 2 ACCESSIBLE & 1 ACCESSIBLE VAN

#### **KEY NOTES:**

(E) CHAIN LINK OR TUBULAR STEEL FENCING

(E) ACCESSIBLE PARKING AND SIGNAGE REFER TO DETAIL 03, SHEET PF-10.6

(E) PARKING TOW-AWAY SIGNAGE PER DSA #01-108413

(E) ACCESSIBLE STUDENT RESTROOM PER DSA #01-116131

(E) ACCESSIBLE STAFF RESTROOM PER DSA #01-108413

ACCESSIBLE DRINKING FOUNTAIN, PER DETAIL 05, SHEET PF-10.6

(E) ACCESSIBLE PARKING STRIPING, REFER TO DETAIL 02, SHEET PF-10.6

(E) DETECTABLE WARNING. 6" CONCRETE MOWBAND AROUND PERIMETER, SIMILAR TO ADJACENT DETECTABLE WARNINGS.

(E) GATE PER DSA #01-108413. SIGNAGE STATING THAT GATE SHALL REMAIN UNLOCKED

AT ALL TIMES FURING SCHOOL HOURS, REFER TO DETAIL 01, SHEET PF-10.6.

10 SERVICE GATE - FOR VEHICLE ACCESS ONLY.

4' WIDE ACCESSIBLE CHAIN LINK GATE, PER DETAIL 01 ON SHEET PF-10.3.

CONCRETE WALKWAY

VEHICULAR OR MAINTENANCE GATE



NEW CONCRETE WALKWAY

NEW ASPHALT PAVING


NEW COMPACTED BASE ROCK PAVING

NEW LANDSCAPING PER PLANTING PLAN Ψ Ψ Ψ Ψ Ψ V V V V

ACCESSIBLE ROUTE



KEYNOTE CALLOUT SYMBOL

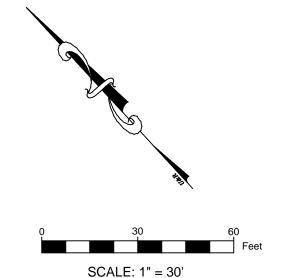



7349 N. VIA PASEO DEL SUR

SUITE 515-324

SCOTTSDALE, ARIZONA 85258

PH 602.635.4226

FAX 602.997.3148

IDENTIFICATION STAMP
DIV. OF THE STATE ARCHITECT OFFICE OF REGULATION SERVICES 01-117698 DATE

DSA BACK CHECK


FOOTHILL HIGH SCHOOL ATHLETIC FIELDS 230 PALA AVENUE

San Jose, CA

SCALE: 1"=30' DESIGNED: BTL DATE: 11/06/2018 DRAWN: BTL PROJ. 18-115 APPROVED:

> OVERALL SITE AND ACCESS PLAN

> > DWG. NO.

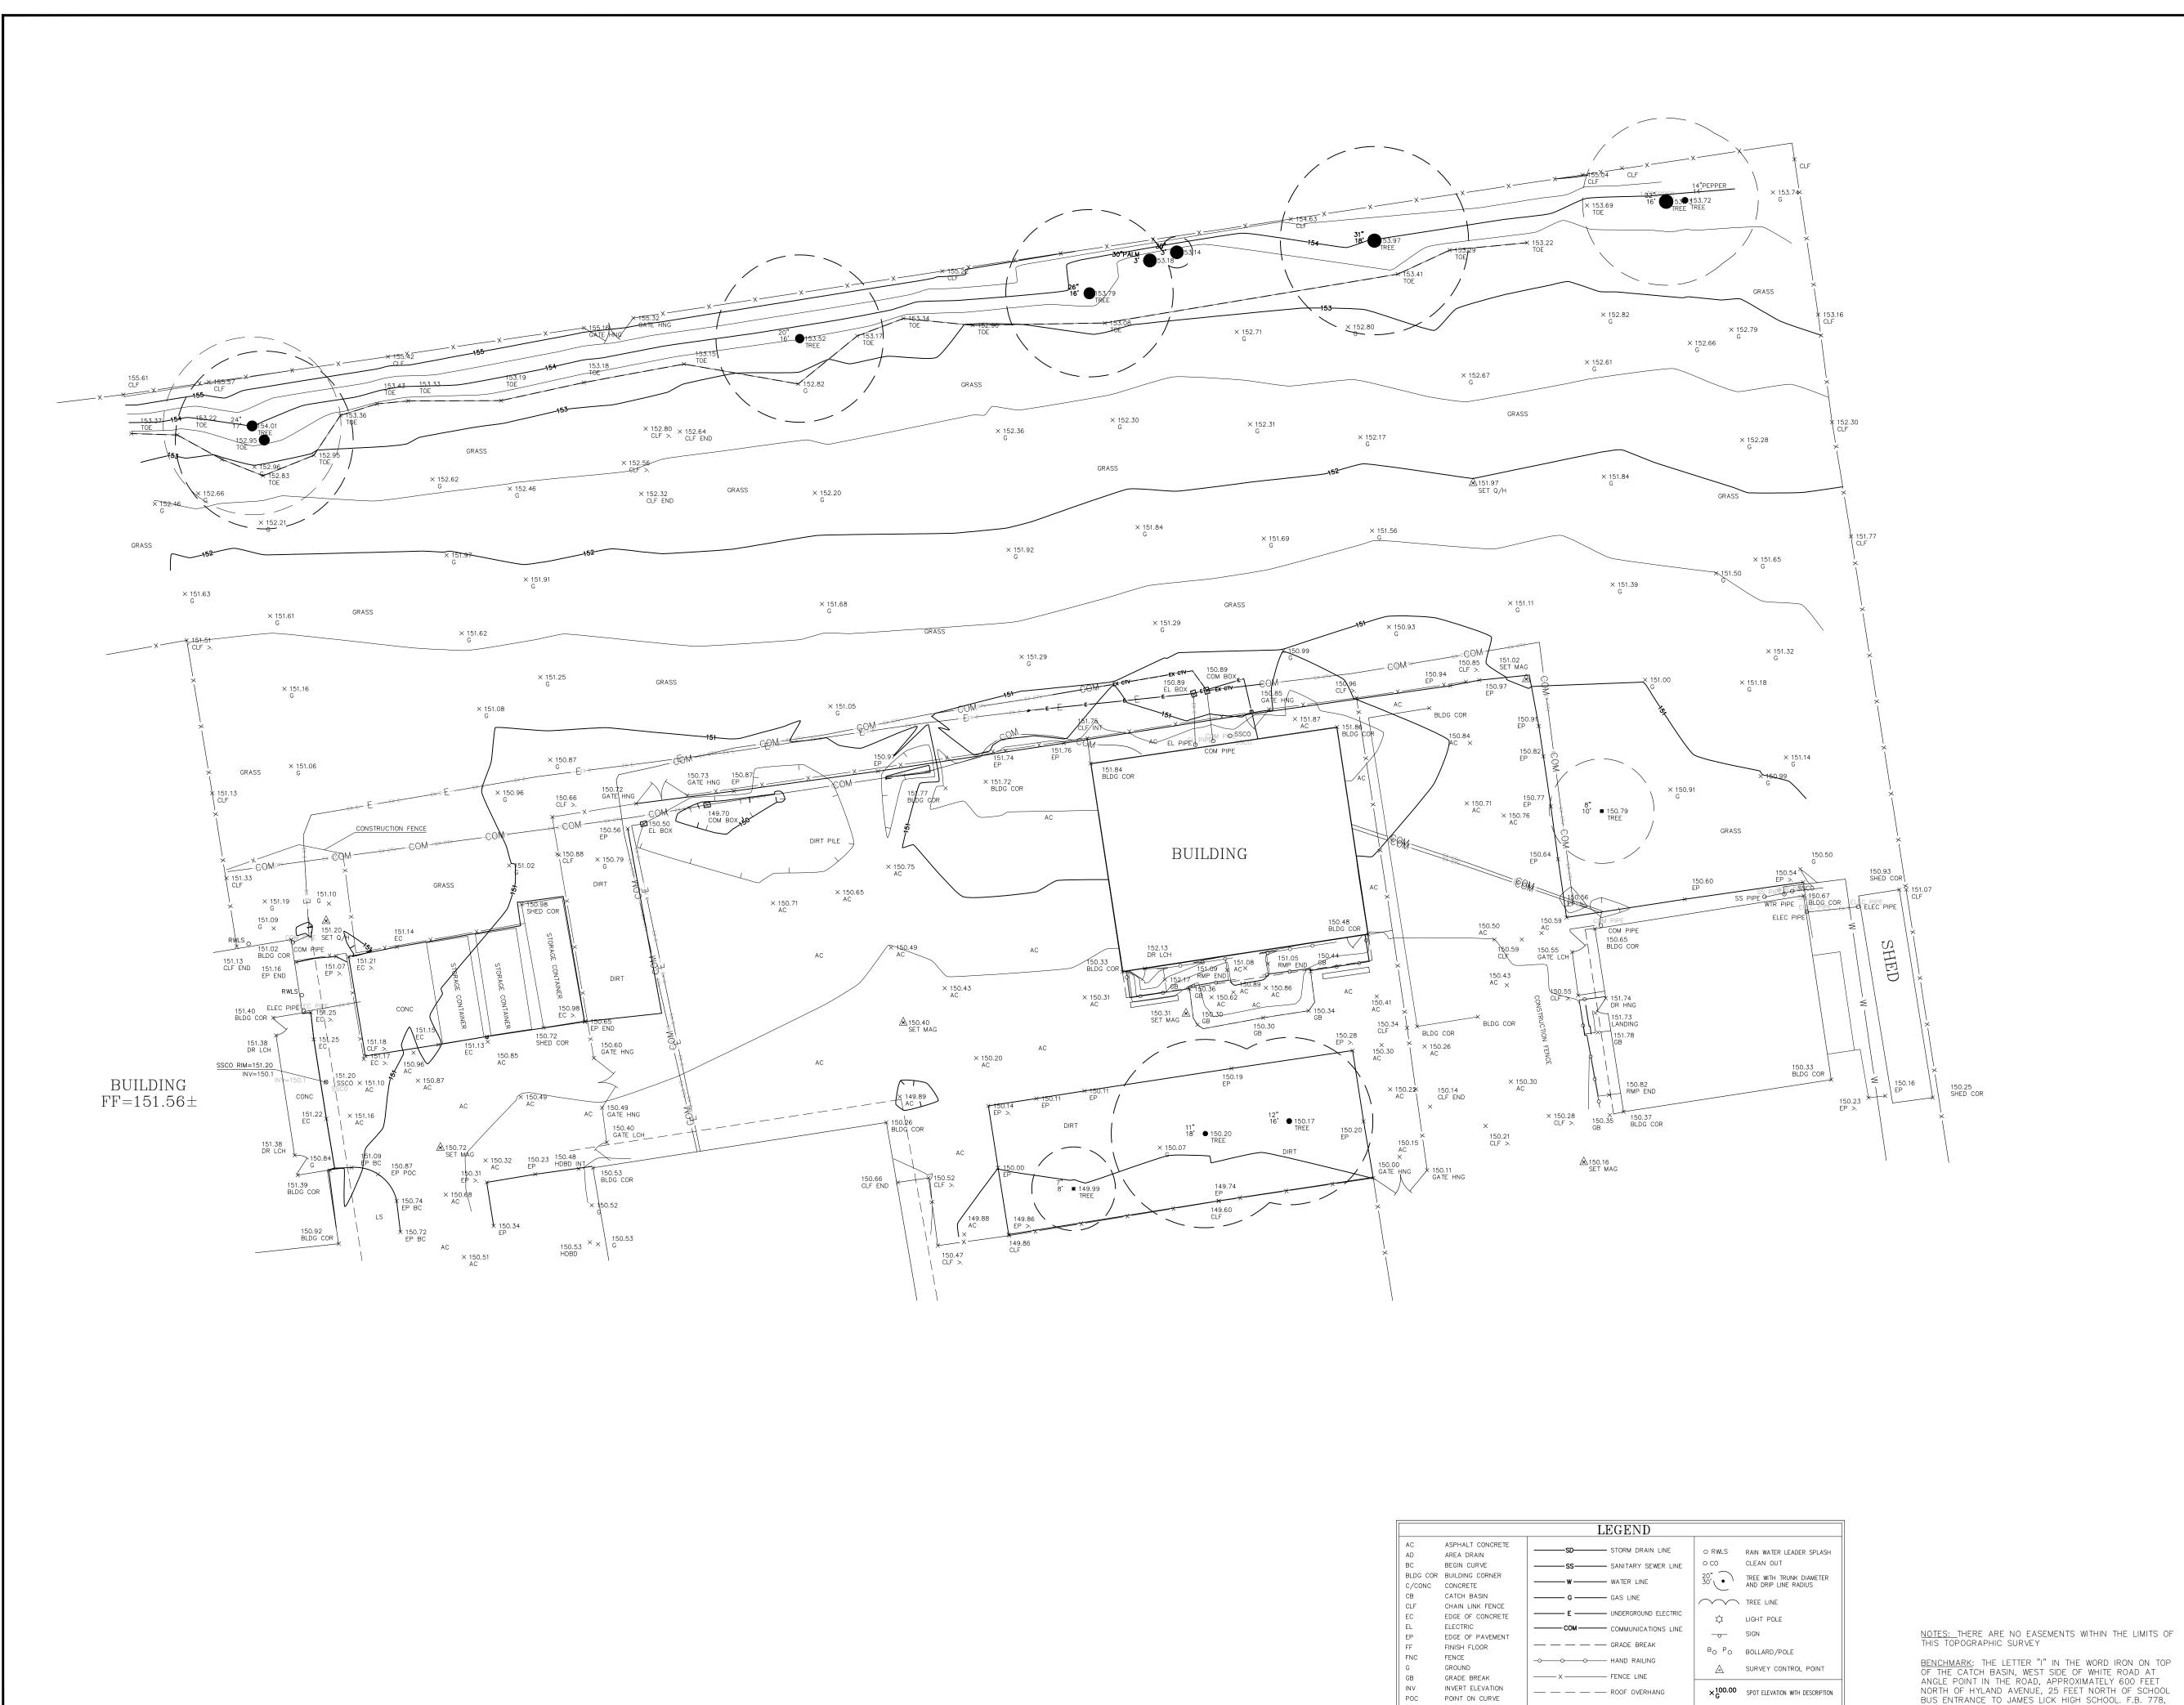





IDENTIFICATION STAMP DIV. OF THE STATE ARCHITECT OFFICE OF REGULATION SERVICES 01-117698 DATE

DSA BACK CHECK

FOOTHILL HIGH SCHOOL ATHLETIC FIELDS 230 PALA AVENUE San Jose, CA

SCALE:	1"=20'
DESIGNED:	BTL
DATE:	11/06/2018
DRAWN:	BTL
PROJ.	18-115

APPROVED:

**EXISTING CONDITIONS** 

DWG. NO. PF-02.1

BENCHMARK: THE LETTER "I" IN THE WORD IRON ON TOP OF THE CATCH BASIN, WEST SIDE OF WHITE ROAD AT ANGLE POINT IN THE ROAD, APPROXIMATELY 600 FEET NORTH OF HYLAND AVENUE, 25 FEET NORTH OF SCHOOL BUS ENTRANCE TO JAMES LICK HIGH SCHOOL. F.B. 778, PAGE 71. BENCHMARK ID 82. REFERENCE MARK—247—D. ELEVATION 158.12

CONTOUR INTERVAL: 1 FOOT

—100 — INDEX ELEVATION CONTOUR


TELEPHONE

BOTTOM OF SLOPE

TOP OF SLOPE

— — — — TRENCH/PATCH LINE

SCALE: 1" = 15'

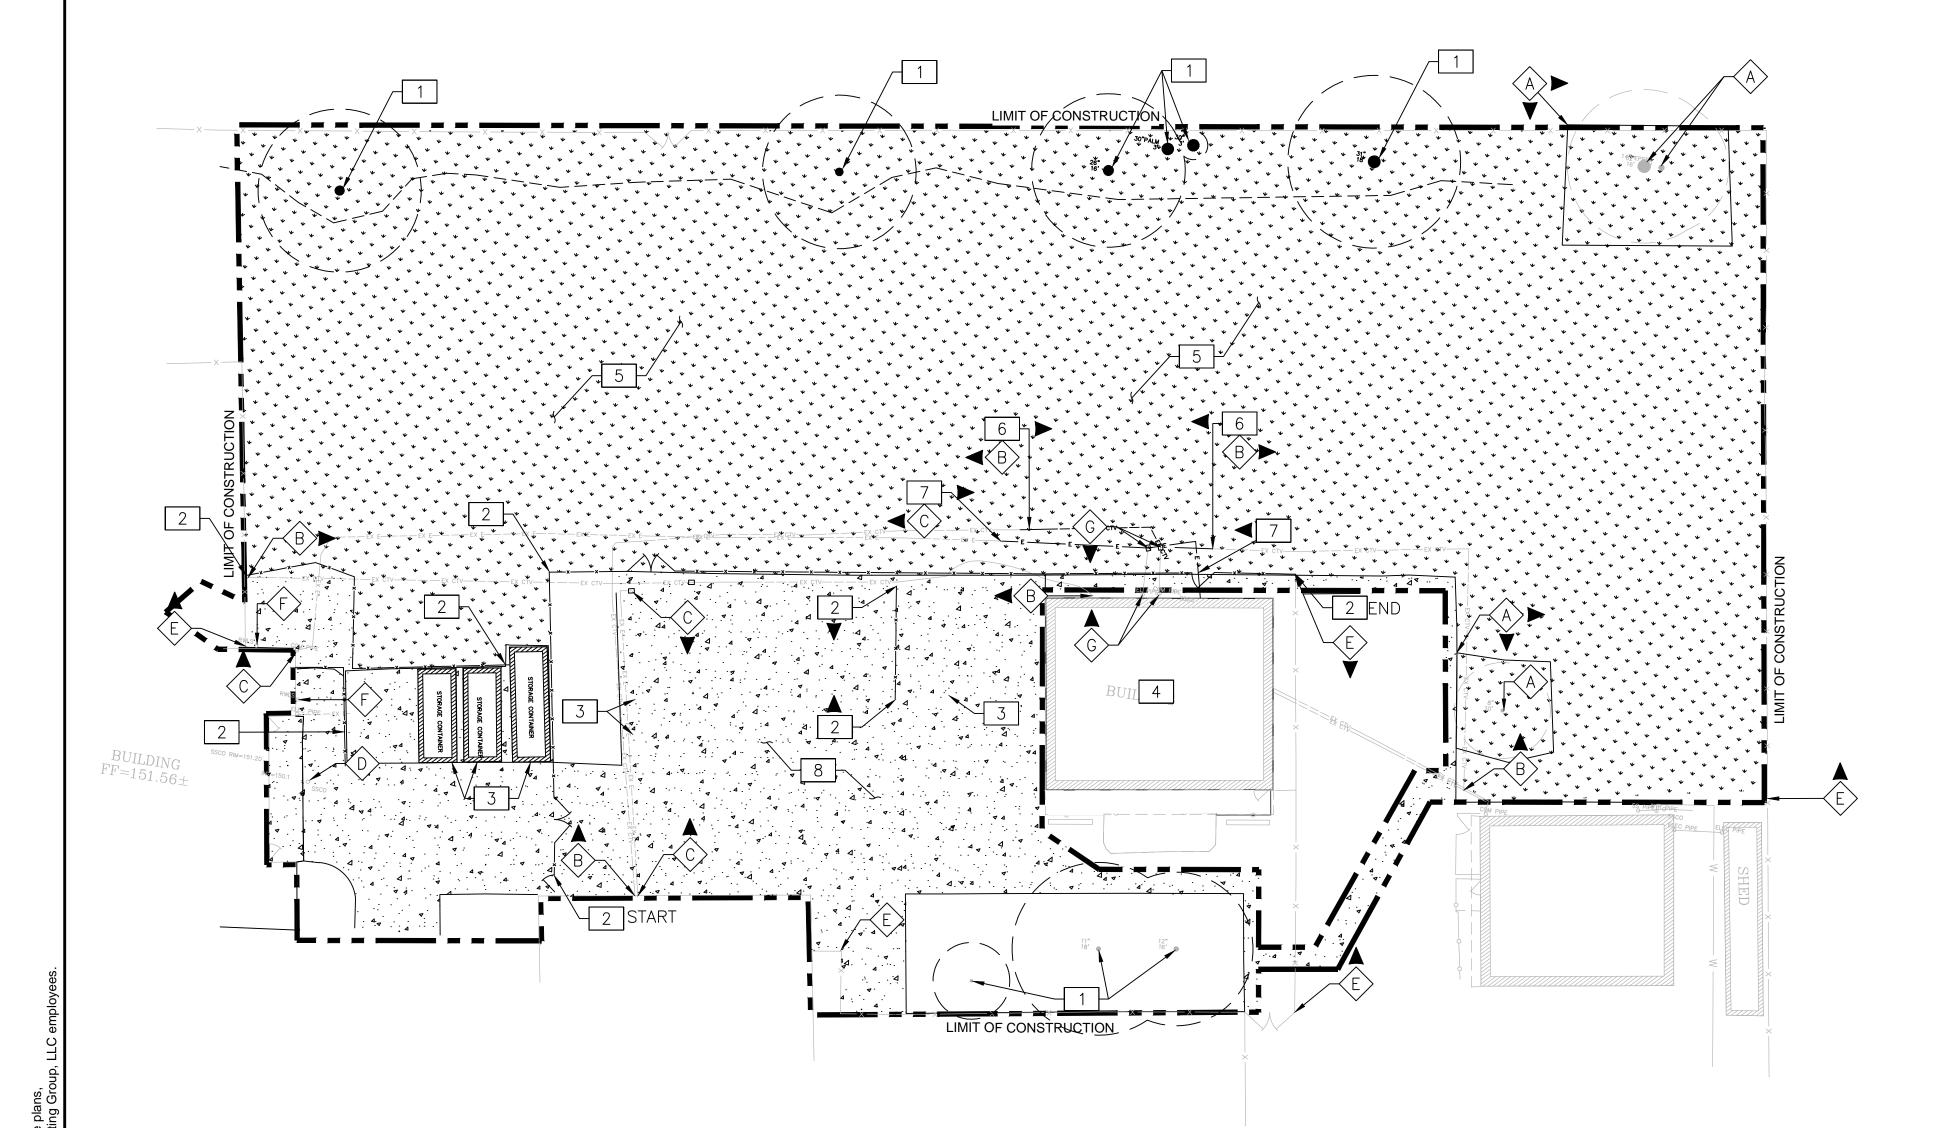

# PROTECT IN PLACE NOTES:

- A PROTECT IN PLACE EXISTING TREES AND ROOTS. CONTRACTOR TO PROVIDE TREE PROTECTION DURING CONSTRUCTION.
- B PROTECT IN PLACE EXISTING COMMUNICATION LINES AND ASSOCIATED UTILITY BOXES.
- C PROTECT IN PLACE EXISTING ELECTRICAL LINE AND ASSOCIATED ELECTRICAL BOXES.
- D PROTECT IN PLACE SANITARY SEWER CLEANOUT.
- E PROTECT IN PLACE EXISTING PERIMETER FENCE AND ALL ASSOCIATED POSTS/FOOTING AND GATES.
- F PROTECT IN PLACE EXISTING RAINWATER LEADER SPLASH.
- G PROTECT IN PLACE EXISTING CONDUIT TO BUILDING

# **DEMOLITION NOTES:**

- 1 REMOVE AND DISPOSE OF EXISTING TREES AND
- 2 REMOVE AND DISPOSE OF EXISTING FENCE AND ASSOCIATED POSTS/FOOTING AND GATES.
- 3 REMOVE AND RETURN STORAGE CONTAINERS TO SCHOOL DISTRICT.
- 4 DEMOLISH EXISTING BUILDING.
- 5 REMOVE AND DISPOSE OF EXISTING NATURAL GRASS AND TOP 2" OF NATIVE SOIL.
- 6 RE-ROUTE EXISTING COMMUNICATION LINE AND ASSOCIATED COMMUNICATION BOXES PER IRRIGATION PLAN ON SHEET PF-08.
- 7 RE-ROUTE EXISTING ELECTRICAL LINE AND ASSOCIATED ELECTRICAL BOXES PER IRRIGATION PLAN ON SHEET PF-08.
- 8 REMOVE AND DISPOSE OF EXISTING CONCRETE.

#### GENERAL DEMOLITION NOTES

- 1. THE CONTRACTOR SHALL VISIT THE SITE PRIOR TO BID SUBMITTAL IN ORDER TO DETERMINE THE EXTENT AND CONDITIONS OF SITE DEMOLITION AND TO FIELD VERIFY SITE CONDITIONS. THE CONTRACTOR SHALL NOTIFY THE OWNER OF ANY DISCREPANCIES PRIOR TO BID.
- 2. THE CONTRACTOR SHALL PERFORM ALL CLEARING, DEMOLITION AND REMOVAL SITE PREPARATIONS NECESSARY FOR THE EXECUTION OF THE WORK CONTAINED IN THE CONTRACT
- 3. EXISTING STORM DRAIN FACILITIES WITHIN THE LIMITS OF CONSTRUCTION SHALL BE PROTECTED FROM CONSTRUCTION DEBRIS INTRUSION. THE CONTRACTOR SHALL FLUSH AND CLEAN EXISTING DRAINAGE SYSTEMS THAT ARE TO BE PROTECTED IN PLACE, WITHIN THE PROJECT LIMITS, TO THE POINT OF DISCHARGE. ALL CLEAN OF SITE AND DRAINAGE SYSTEMS SHALL MEET ALL CALIFORNIA SAFETY AND WATER QUALITY REQUIREMENTS SET BY THE STATE BOARD OF WATER
- 4. THE CONTRACTOR SHALL VERIFY THE LOCATIONS OF ALL UTILITIES, STRUCTURES, AND SERVICES BEFORE COMMENCING WORK. CONTRACTOR IS RESPONSIBLE FOR POT-HOLING AND UTILITY SURVEYS AS NECESSARY TO LOCATE EXISTING
- 5. THE CONTRACTOR SHALL PROVIDE ALL NECESSARY BMP's AND PROTECTIONS TO DRAINS AND DRAINAGE SYSTEMS AS REQUIRED BY THE PROJECT SWPPP DOCUMENTS AND CALIFORNIA STATE WATER RESOURCES CONTROL BOARD PRIOR TO COMMENCING DEMOLITION.
- 6. CONTRACTOR SHALL BE RESPONSIBLE FOR REPAIRING OR REPLACING ANY EXISTING ITEM DAMAGED OR DESTROYED BY CONSTRUCTION NOT IDENTIFIED FOR DEMOLITION OR REMOVAL. REPLACEMENT OR REPAIRS SHALL BE AT THE CONTRACTOR'S EXPENSE AND ITEM RESTORED TO EQUAL OR BETTER
- 7. THE CONTRACTOR SHALL PROVIDED NECESSARY MEASURES TO CONTROL DUST AND ARBOR SEDIMENT PER PER THE SWPPP DOCUMENTS AND AS REQUIRED BY THE STATE.
- 8. REFER TO AS-BUILT DRAWINGS AND GEOTECHNICAL REPORT FOR DEPTH OF EXISTING PAVING AND BASES.
- 9. CONTRACTOR MUST REMOVE AND DISPOSE OF ALL WEEDS, LOOSE MATERIALS.
- 10. THE CONTRACTOR SHALL OBTAIN ANY REQUIRED PERMITS PRIOR TO DEMOLITION.
- 11. CONTRACTOR IS RESPONSIBLE FOR MAINTAINING IRRIGATION SERVICE TO EXISTING LANDSCAPE MATERIAL TO REMAIN AND TO ADJACENT FIELDS BOTH DURING AND AFTER CONSTRUCTION.
- 12. THE CONTRACTOR MUST CONTACT LOCAL UTILITY LOCATION SERVICES PRIOR TO CONSTRUCTION.
- 13. THE CONTRACTOR MUST PROTECT IN PLACE ALL EXISTING UTILITIES.
- 14. THE CONTRACTOR IS RESPONSIBLE FOR REPAIR OR REPLACEMENT OF UTILITIES DAMAGED DURING CONSTRUCTION.
- 15. REFER TO REGARDING
- 16. CONTRACTO ANY DEMOI


CTION.	IDENTIFICATION STAMP DIV. OF THE STATE ARCHITECT OFFICE OF REGULATION SERVICES
SPECIFICATIONS FOR ADDITIONAL INFORMATION G DEMOLITION.	01-117698
OR SHALL NOTIFY USA 800-227-2600 PRIOR TO DITION OR EXCAVATION.	AC FLS SS DATE

		I_	EGEND		
AC AD	ASPHALT CONCRETE AREA DRAIN	SD	- STORM DRAIN LINE	o RWLS	RAIN WATER LEADER SPLASH
BC	BEGIN CURVE	ss	- SANITARY SEWER LINE	0 CO	CLEAN OUT
BLDG COR C/CONC	BUILDING CORNER CONCRETE	w	- WATER LINE	20"	TREE WITH TRUNK DIAMETER AND DRIP LINE RADIUS
СВ	CATCH BASIN	G	- GAS LINE		TREE LINE
CLF EC	CHAIN LINK FENCE EDGE OF CONCRETE	—— Е ——	- UNDERGROUND ELECTRIC	<b>\$</b>	LIGHT POLE
EL	ELECTRIC	——— сом ———	- COMMUNICATIONS LINE		SIGN
EP	EDGE OF PAVEMENT		- GRADE BREAK	-	SIGN
FF FNC	FINISH FLOOR		GRADE BREAK	Bo Po	BOLLARD/POLE
G GB	FENCE GROUND GRADE BREAK	x	– HAND RAILING – FENCE LINE	<u> </u>	SURVEY CONTROL POINT
INV POC	INVERT ELEVATION POINT ON CURVE		- ROOF OVERHANG	× <sub>G</sub> 100.00	SPOT ELEVATION WITH DESCRIPTION
TEL	TELEPHONE		- BUILDING LINE	100	INDEX ELEVATION CONTOUR
TOE TOP	BOTTOM OF SLOPE TOP OF SLOPE		- TRENCH/PATCH LINE	<u> </u>	INTERMEDIATE ELEVATION CONTOUR

NOTES: THERE ARE NO EASEMENTS WITHIN THE LIMITS OF THIS TOPOGRAPHIC SURVEY

BENCHMARK: THE LETTER "I" IN THE WORD IRON ON TOP OF THE CATCH BASIN, WEST SIDE OF WHITE ROAD AT ANGLE POINT IN THE ROAD, APPROXIMATELY 600 FEET NORTH OF HYLAND AVENUE, 25 FEET NORTH OF SCHOOL BUS ENTRANCE TO JAMES LICK HIGH SCHOOL. F.B. 778, PAGE 71 BENCHMARK ID 82. REFERENCE MARK-247-D. ELEVATION 158.12

CONTOUR INTERVAL: 0.5 FOOT

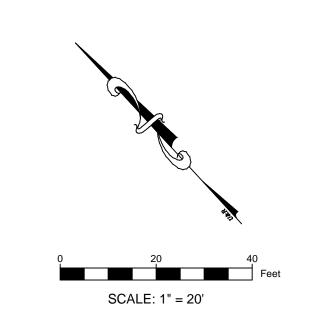

DSA BACK CHECK

11/06/18
Date
OF CALIF

7349 N. VIA PASEO DEL SUR SUITE 515-324 SCOTTSDALE, ARIZONA 85258

PH 602.635.4226


FAX 602.997.3148

FOOTHILL HIGH SCHOOL ATHLETIC FIELDS 230 PALA AVENUE San Jose, CA

SCALE: 1"=20' DESIGNED: BTL 11/06/2018 DATE: DRAWN: PROJ. 18-115 APPROVED:

**DEMOLITION PLAN** 


DWG. NO.

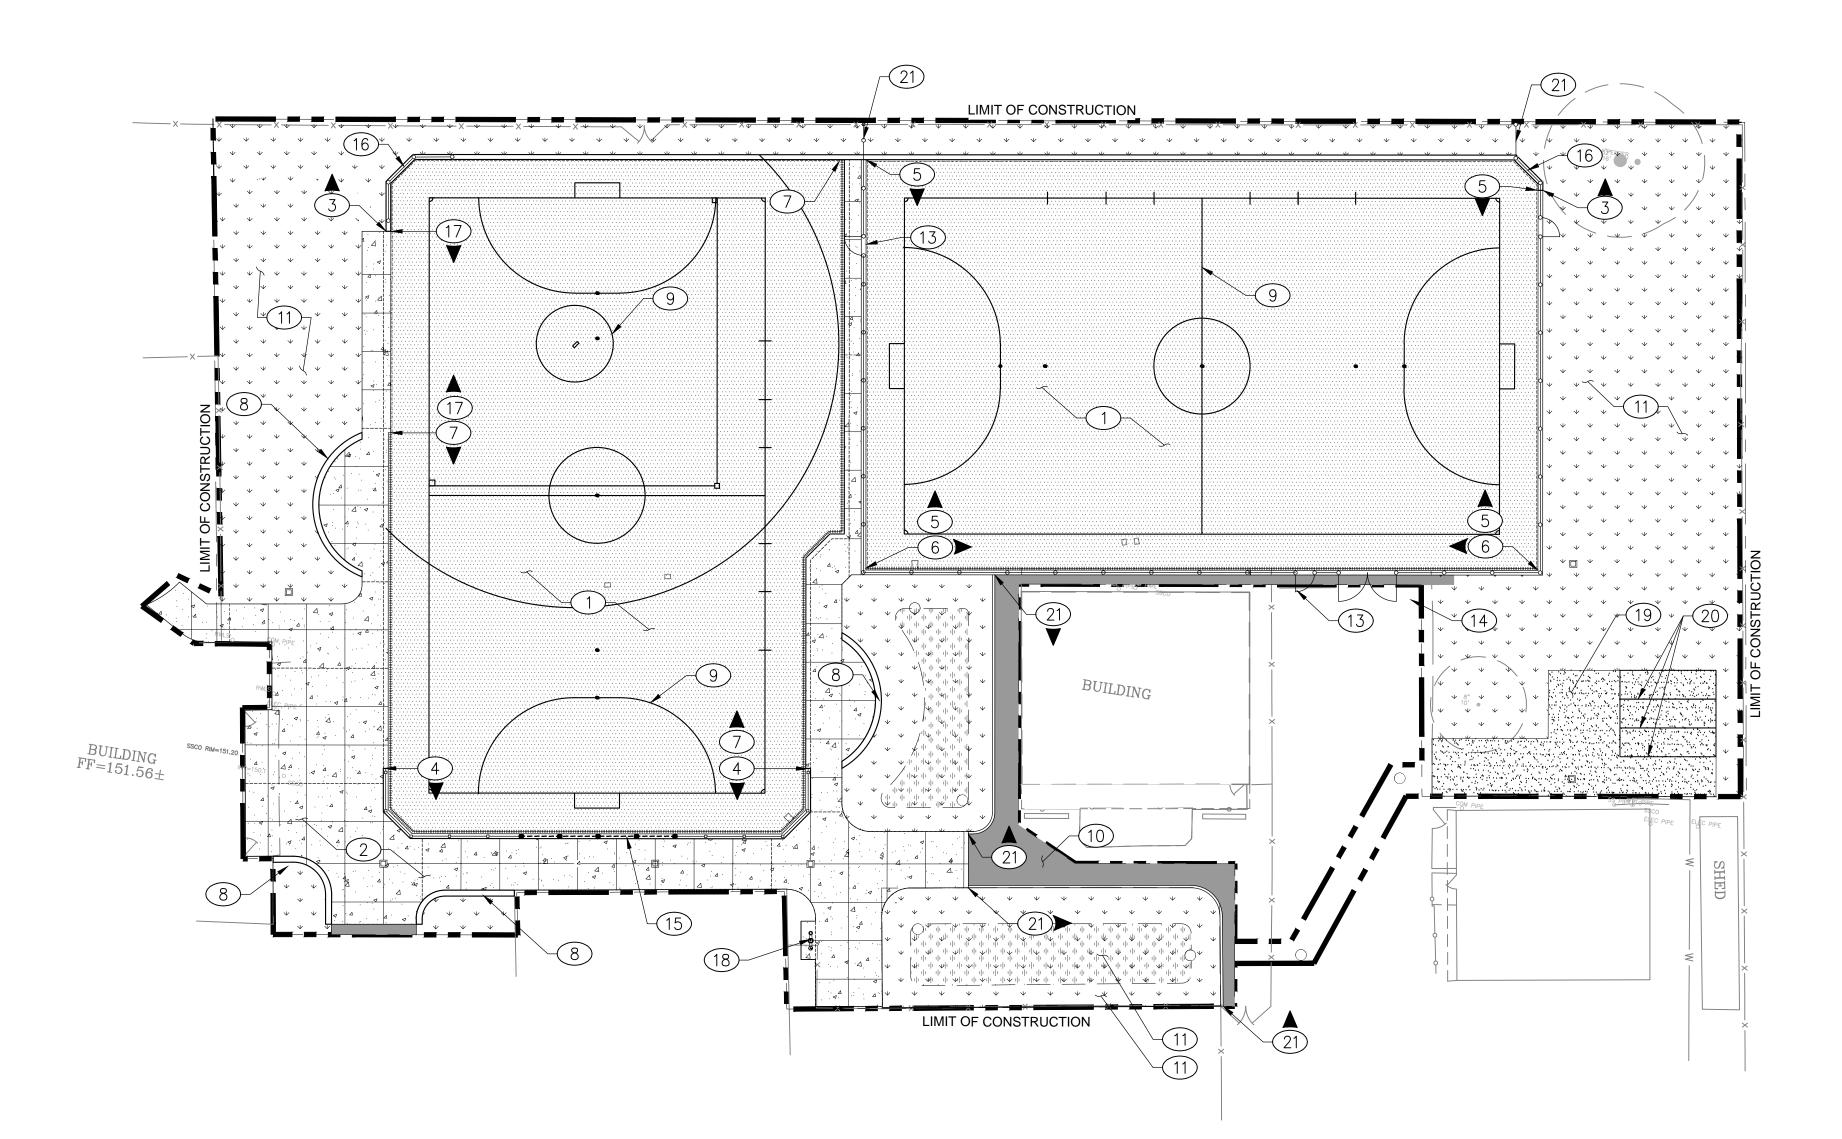

#### SURFACING KEY NOTES:

- 1) INSTALL SYNTHETIC TURF WITH SHOCK/DRAIN PAD AND BASE ROCK, PER DETAILS 01, SHEET PF-10.2.
- 2 INSTALL CONCRETE PAVING NATURAL GRAY COLOR W/ LIGHT BROOM FINISH, DETAILS 02 AND 10, SHEET PF-10.2.
- 3 INSTALL CONCRETE RETAINING CURB, PER DETAIL 08 & 12, SHEET
- 4 INSTALL 4' TUBULAR STEEL FENCE PER DETAILS 06, SHEET PF-10.3 & DETAIL 05, SHEET PF-10.2.
- 5 INSTALL 12' CHAIN LINK FENCE & 12" EDGE CURB, PER DETAIL 04, SHEET PF-10.2 & DETAIL 01, SHEET PF10.3. 6 INSTALL SLOTTED DRAIN, CONCRETE CURB & 12' CHAIN LINK FENCE, PER DETAIL 05, SHEET PF-10.2.
- 7 INSTALL SLOTTED DRAIN & CONCRETE CURB, PER DETAIL 06, SHEET
- INSTALL CONCRETE ACCENT CURB, PER DETAIL 07 & 12, SHEET
- (9) INSTALL FIELD STRIPING DIMENSIONS, PER GRAPHICS PLAN.
- 10) INSTALL ASPHALT PAVING, PER DETAIL 03, SHEET PF-10.2.
- (11) INSTALL LANDSCAPE AREA, PER PLANTING PLAN.
- 12 INSTALL BIO-RETENTION INFILTRATION AREA PROFILE, PER PLANTING PLAN, AND DETAIL 03 & 04, SHEET PF-10.5.
- (13) INSTALL 4' PEDESTRIAN GATE, PER DETAIL 01, SHEET PF-10.3.
- (14) INSTALL 12' VEHICLE ACCESS GATE, PER DETAIL 08, SHEET PF-10.3.
- 15) INSTALL 12' BALL STOP NETTING, PER DETAIL 05, SHEET PF-10.3.
- 16 INSTALL 12' BACKSTOP FENCE VINYL COATED (BLACK).
- 17) INSTALL SYNTHETIC TURF PLASTIC NAILER
- 18) INSTALL DRINKING FOUNTAIN, PER DETAIL 05, SHEET PF-10.6.
- (19) INSTALL COMPACTED BASE PAD, PER SPECIFICATIONS.
- 20) RELOCATE EXISTING CONTAINERS.
- 21) INSTALL 12' CHAIN LINK FENCING TO CONNECT TO EXISTING PROPERTY BETWEEN RETAINING CURB & PROPERTY FENCING.

# SURFACING LEGEND

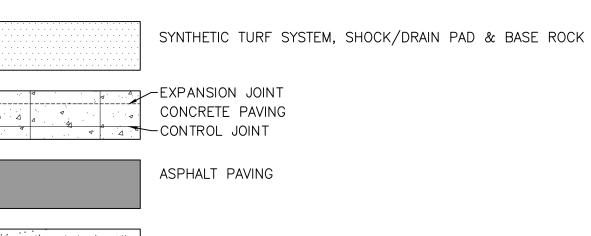

COMPACTED BASE ROCK PAVING LANDSCAPING PER PLANTING PLAN


BIORETENTION INFILTRATION AREA

\_\_\_\_\_ 4' TUBULAR STEEL FENCE (BLACK), 

SLOT DRAIN

KEYNOTE CALLOUT SYMBOL

LIMITS OF CONSTRUCTION

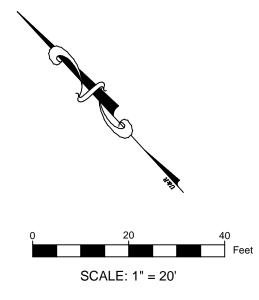

7349 N. VIA PASEO DEL SUR SUITE 515-324 SCOTTSDALE, ARIZONA 85258 PH 602.635.4226 FAX 602.997.3148



IDENTIFICATION STAMP DIV. OF THE STATE ARCHITECT OFFICE OF REGULATION SERVICES 01-117698

DATE


DSA BACK CHECK

FOOTHILL HIGH SCHOOL ATHLETIC FIELDS 230 PALA AVENUE San Jose, CA

SCALE: 1"=20' DESIGNED: BTL DATE: 11/06/2018 DRAWN: BTL PROJ. 18-115

APPROVED: SURFACING PLAN

DWG. NO.

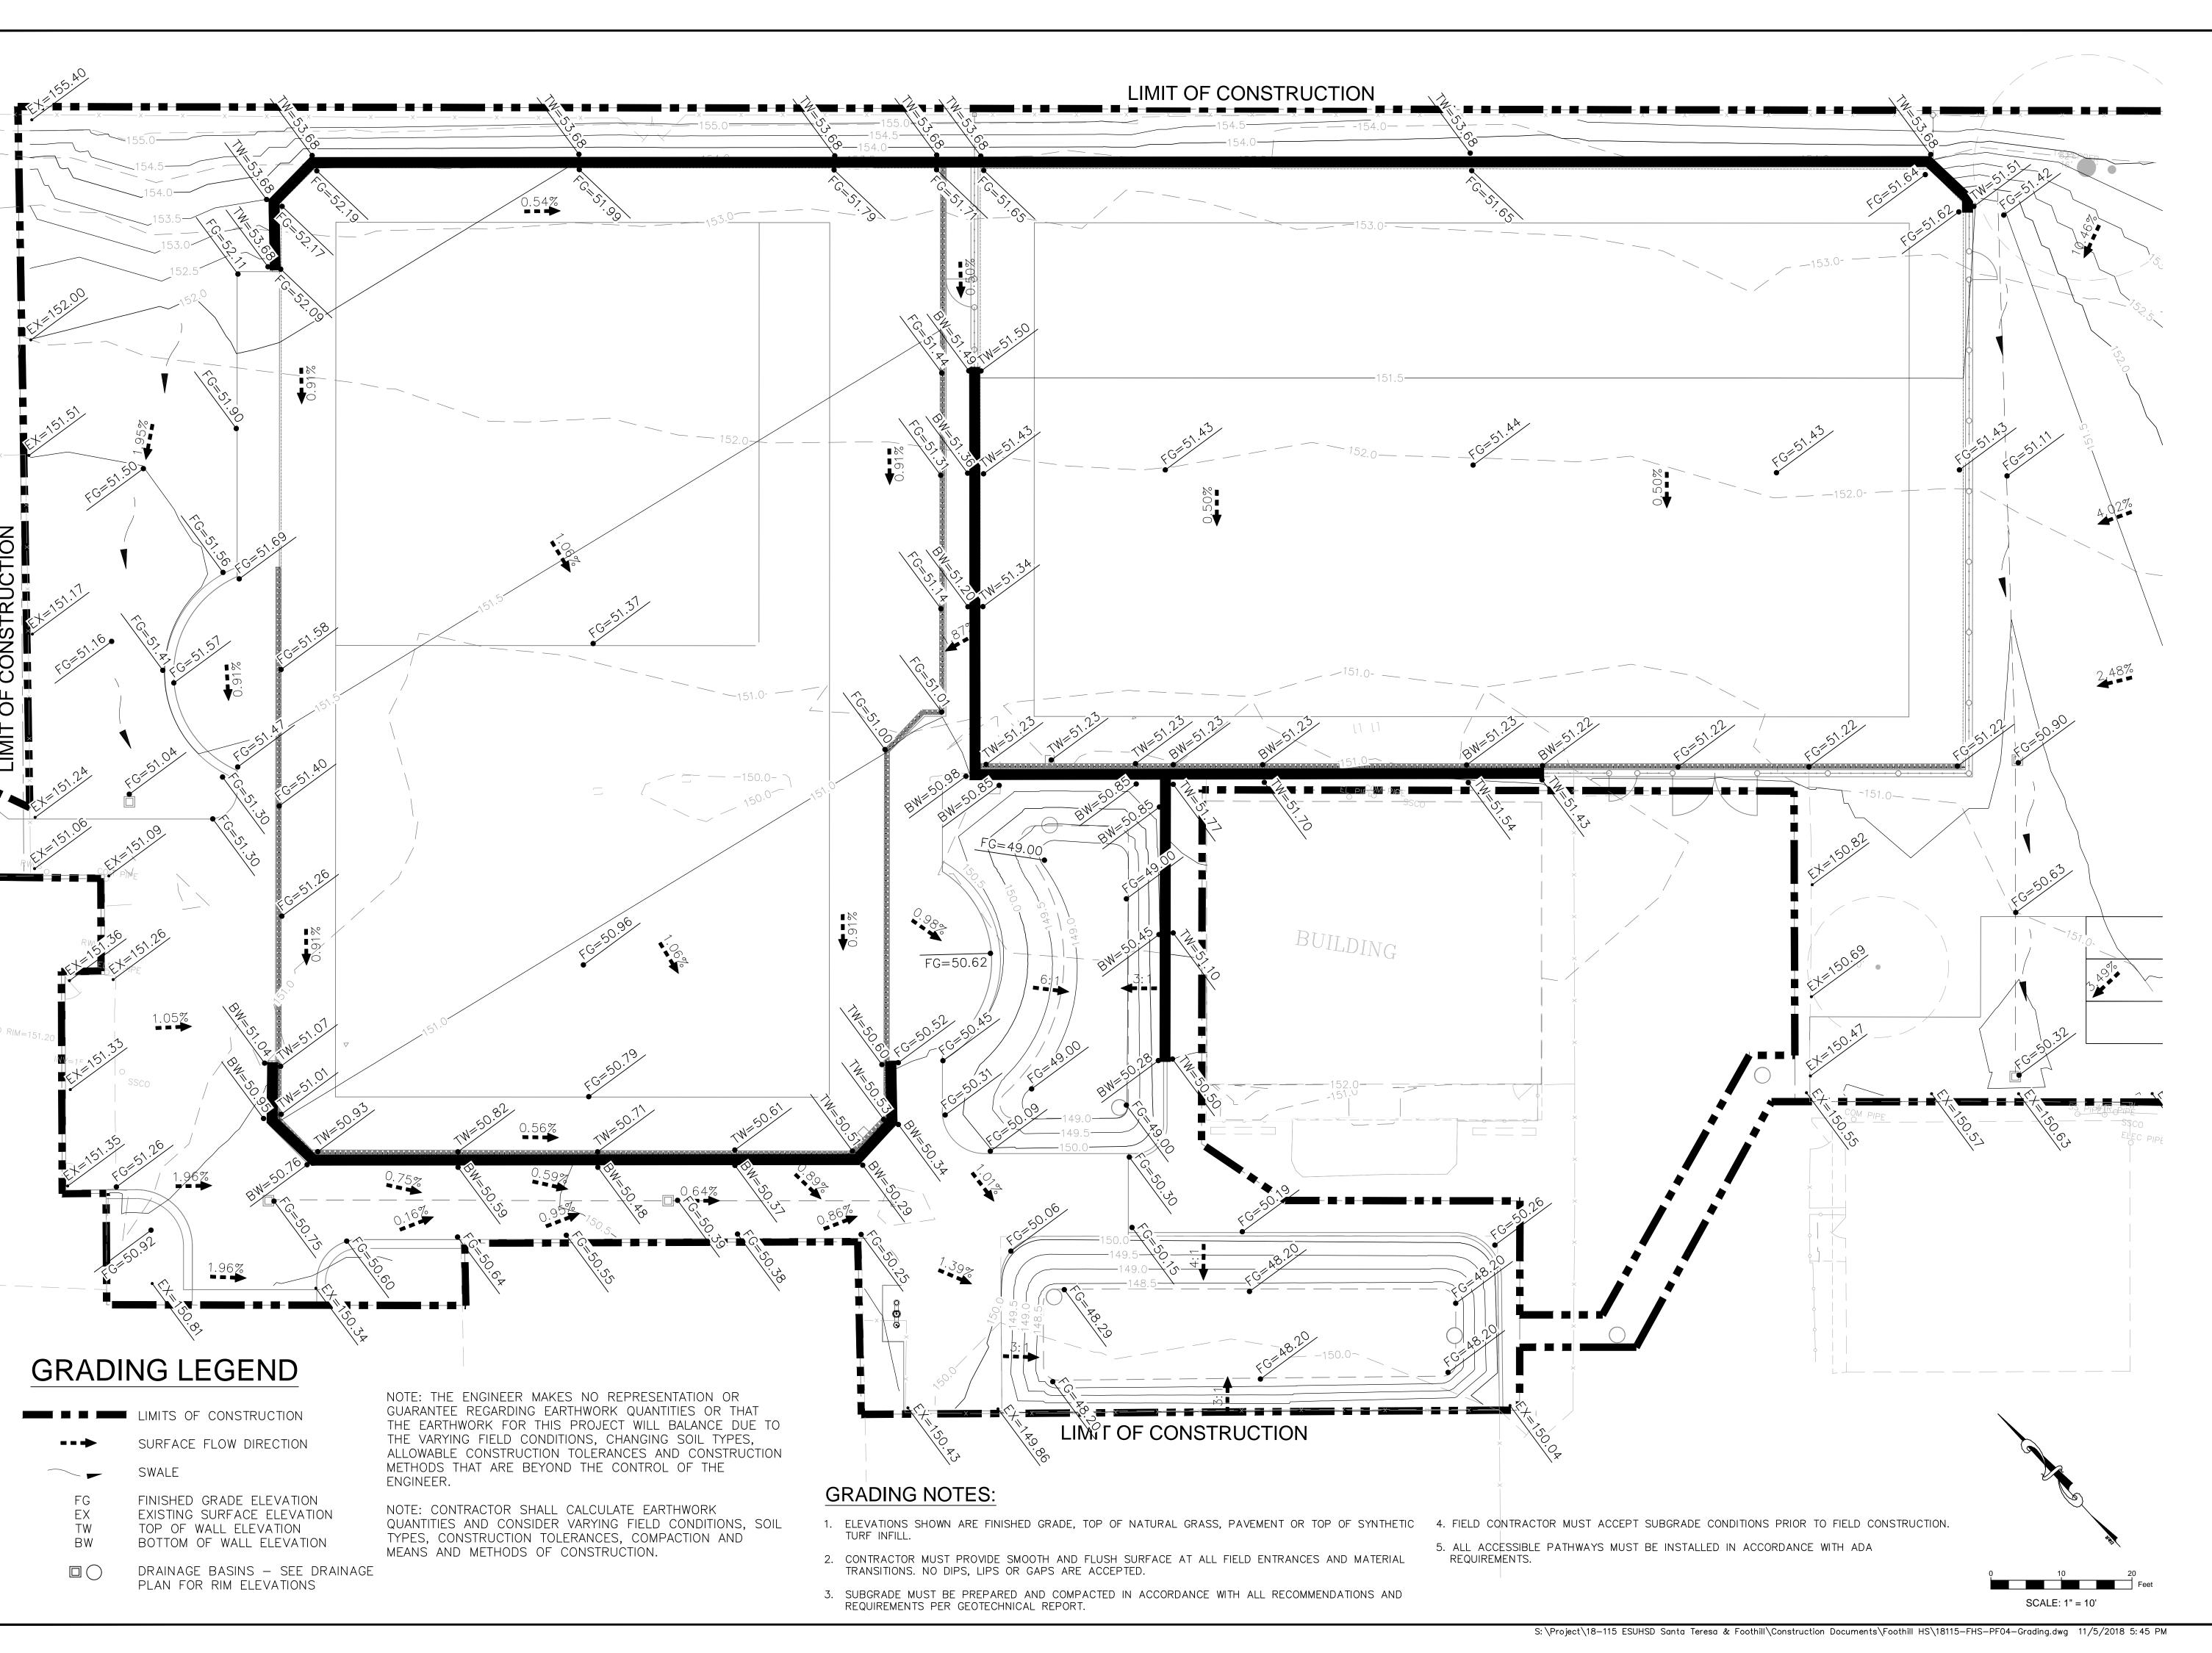



Signature
03 - 31 - 2020
Renewal Date
11/06/18
Date
OF CAL WORTH

IDENTIFICATION STAMP
DIV. OF THE STATE ARCHITECT
OFFICE OF REGULATION SERVICES

01-117698

AC FLS SS

DSA BACK CHECK


REV

FOOTHILL HIGH SCHOOL ATHLETIC FIELDS 230 PALA AVENUE San Jose, CA

SCALE:	1"=10'
DESIGNED:	BTL
DATE:	11/06/2018
DRAWN:	TML
PROJ.	18-115
APPROVED:	

**GRADING PLAN** 

DWG. NO.

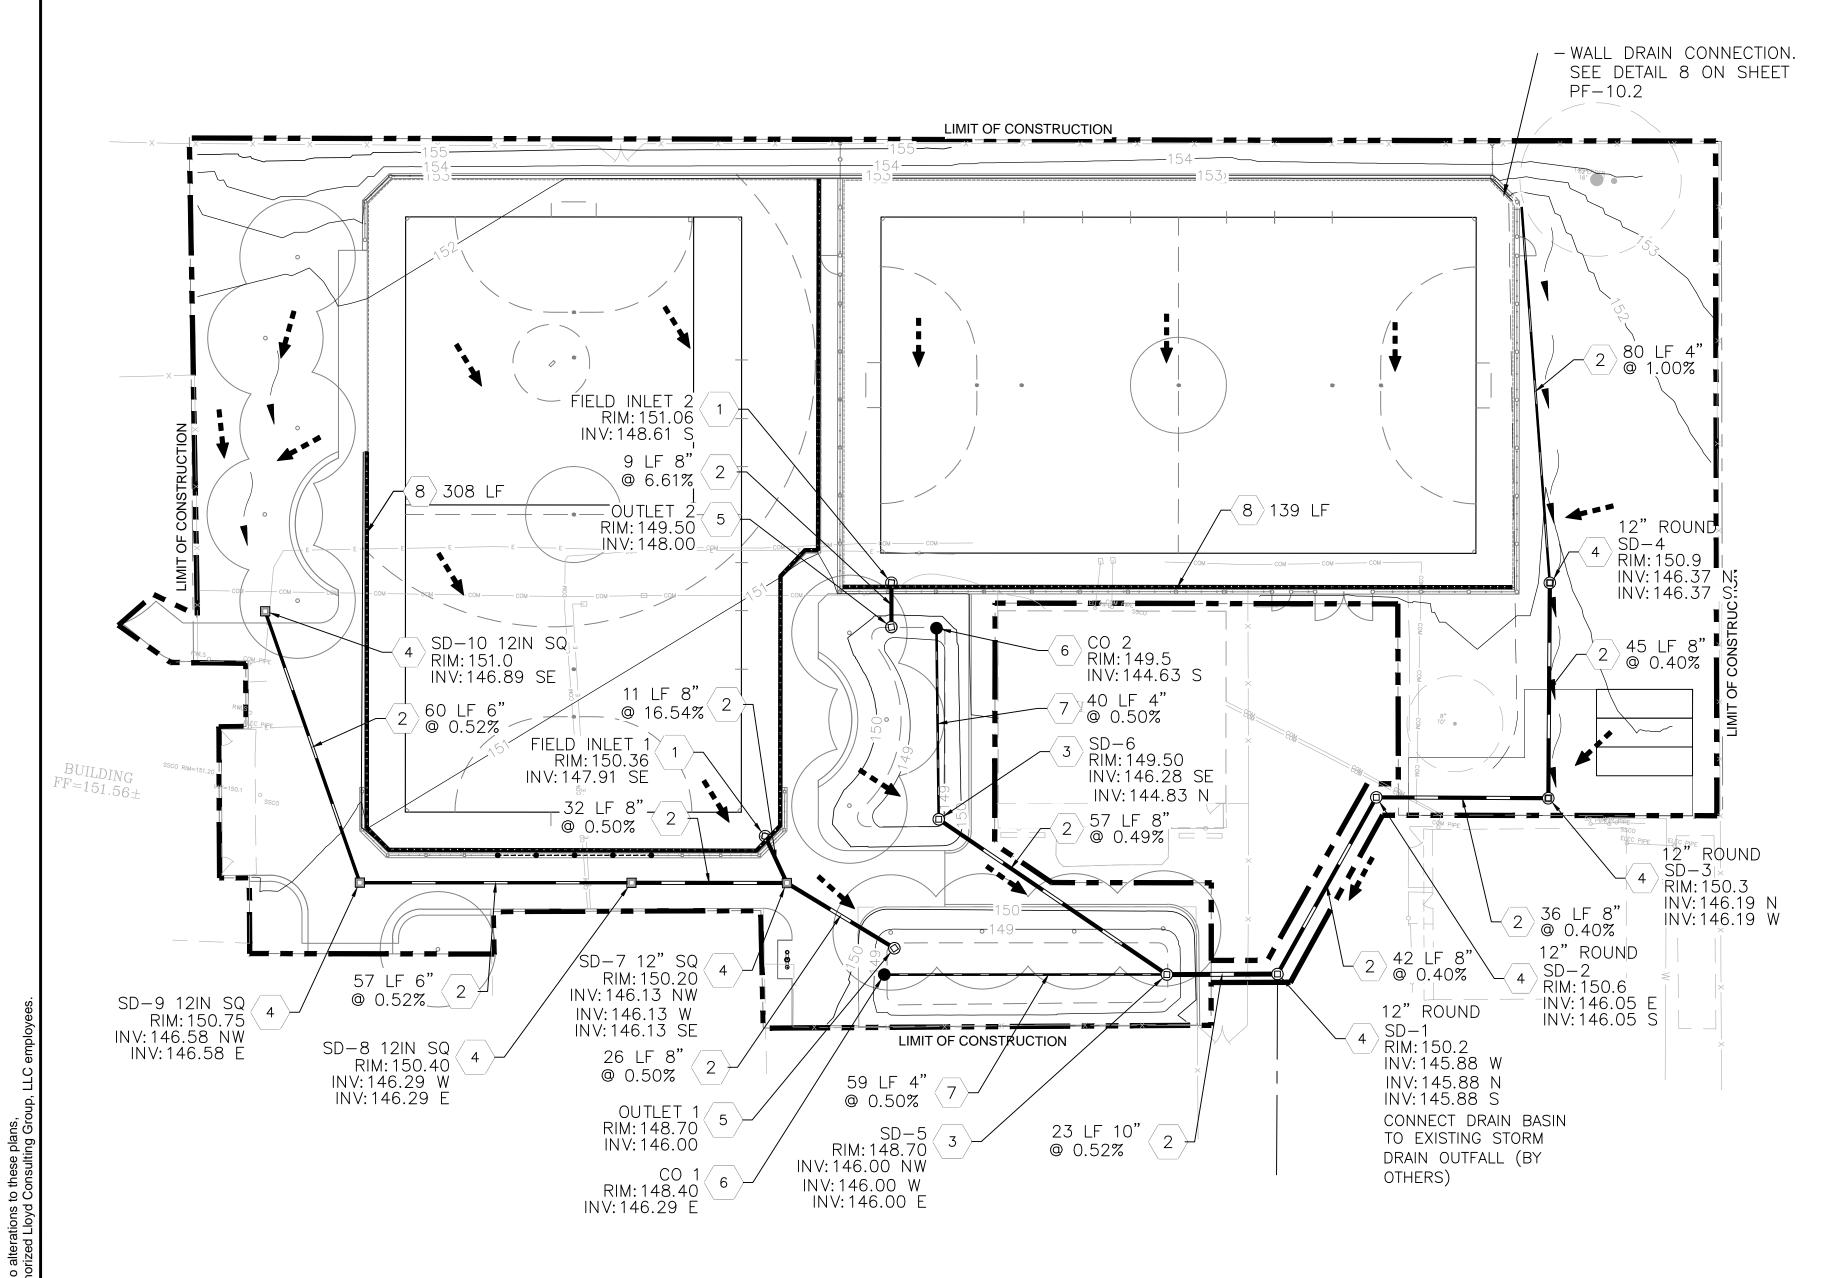

# **GENERAL NOTES:**

- 1. THE CONTRACTOR SHALL VERIFY THE LOCATIONS OF ALL EXISTING UTILITIES, STRUCTURES, AND SERVICES BEFORE COMMENCING WORK. THE LOCATIONS OF UTILITIES, STRUCTURES, AND SERVICES SHOWN IN THE CONTRACT DOCUMENTS SHALL BE DEEMED TO BE APPROXIMATIONS ONLY. ALL DISCREPANCIES BETWEEN WHAT IS SHOWN AND THE ACTUAL FIELD CONDITIONS SHALL BE REPORTED TO THE DISTRICT REPRESENTATIVE. THE CONTRACTOR SHALL CONTACT UNDERGROUND SERVICE ALERT (USA) AT (800) 227–2600 PRIOR TO ANY DEMOLITION OR EXCAVATION. UPON COMPLETION OF USA MARKING OPERATIONS, CONTRACTOR SHALL RECORD ALL UTILITY MARKINGS ON A SEPARATE SET OF DRAWINGS. THIS SET SHALL BE KEPT ON—SITE FOR REFERENCE FOR DURATION OF CONTRACT.
- 2. ALL EXISTING DRAINAGE STRUCTURES, BOXES, UTILITY VAULTS, ETC. TO REMAIN, SHALL BE BROUGHT TO FINAL FINISH GRADE PRIOR TO FINAL SURFACE TREATMENT.
- 3. THE CONTRACTOR IS TO PROTECT DRAINAGE SYSTEM FROM DEBRIS, INCLUDING SOIL, ROCK MATERIAL, AND TRASH FROM ENTERING THE PIPE DURING CONSTRUCTION. CONTRACTOR SHALL AVOID PLACING CONSTRUCTION VEHICLES OVER INSTALLED DRAINAGE TRENCHES TO PREVENT CRUSHING OF PIPE.
- 4. COORDINATE ALL SLEEVING AND UTILITY LOCATIONS AS SHOWN ON THE PLANS AND DETAILS CONTAINED WITHIN THESES CONTRACT DOCUMENTS.
- 5. THE CONTRACTOR IS TO ENSURE THAT ALL REMAINING ACTIVE AND NEW DRAINAGE AND UTILITY LINES ARE PROTECTED AND UNDAMAGED FROM TRENCHING AND FOOTING EXCAVATIONS FOR NEW FOOTINGS, PARTICULARLY FOR NEW FENCING AND WALLS.
- 6. ALL ABANDONED STORM LINES SHALL REMAIN IN PLACE UNLESS IN CONFLICT WITH PROPOSED DRAINAGE, UTILITY, OR SUBGRADING OPERATIONS, IN WHICH CASE ABANDONED PIPE IN CONFLICT SHALL BE REMOVED. REMAINING ABANDONED STORM PIPE SHALL BE SEALED WITH APPROPRIATELY SIZED CONCRETE CAP (3 SACK MIX) 6" ENVELOPE OUTSIDE AND INSIDE DIAMETER OF PIPE.
- 7. PRIOR TO ALL DRAINAGE AND UTILITY WORK, CONTRACTOR SHALL BE RESPONSIBLE FOR VERIFYING ALL POTENTIAL DRAINAGE CONNECTIONS AND EXISTING UTILITY BY POTHOLING. IN ADDITION, ALL DOWNSTREAM CONNECTIONS TO EXISTING STRUCTURES SHALL BE THE START OF THESE OPERATIONS, AND GRADES SHALL BE VERIFIED. CONTRACTOR SHALL FLUSH AND RUN CAMERAS THROUGH EXISTING DRAINAGE SYSTEM WITHIN LIMIT OF WORK TO VERIFY SYSTEM'S INTEGRITY.
- 8. LENGTHS OF DRAIN LINES BETWEEN PROPOSED AND EXISTING ELEMENTS AND INVERT ELEVATIONS OF PROPOSED DRAINAGE STRUCTURES ON EXISTING DRAIN LINES ARE APPROXIMATE AND SHALL BE VERIFIED IN THE FIELD.

# DRAINAGE PLAN NOTES:

- 1) INSTALL 24" ROUND DRAIN BASIN BELOW SYNTHETIC TURF PLAYING FIELD PER SPECIFICATIONS AND PER DETAIL 07 ON SHEET PF-10.1.
- 2 INSTALL NON-PERFORATED SMOOTH INTERIOR CHDPE PIPE PER SPECIFICATIONS AND PER DETAIL 02 ON SHEET PF-10.1. (SIZE PER PLAN)
- 3 INSTALL 24" ROUND DRAIN BASIN WITH RAISED GRATED RIM FOR BIO-RETENTION INLET PER SPECIFICATIONS AND PER DETAIL 03 ON SHEET PF-10.1. (SIZE PER DETAIL)
- 4 INSTALL ROUND DRAIN BASIN WITH GRATED RIM PER SPECIFICATIONS AND PER DETAIL 05 ON SHEET PF-10.1. (SIZE PER PLAN)
- 5 INSTALL 24" ROUND DRAIN BASIN WITH RAISED GRATED RIM FOR BIO-RETENTION OUTLET PER SPECIFICATIONS AND PER DETAIL 04 ON SHEET PF-10.1. (SIZE PER DETAIL)
- $\langle 6 \rangle$  install cleanout with raised Rim per detail of on sheet pf-10.1.
- 7 INSTALL PERFORATED SMOOTH INTERIOR CHDPE DRAIN PIPE PER SPECIFICATIONS AND PER DETAIL 08 ON SHEET PF-10.1. (SIZE PER PLAN)
- 8 8 INCH SLOTTED DRAIN & SYNTHETIC TURF EDGE FASTENER SYSTEM "TERMINATOR XT-8 COLLECTOR DRAIN BY SPORTSEDGE." ENCASED IN CONCRETE. SEE DETAIL 06 ON SHEET PF-10.2.

# DRAINAGE LEGEND

LIMITS OF CONSTRUCTION

PERFORATED CHDPE STORM DRAIN PIPE


NON-PERFORATED CHDPE STORM DRAIN PIPE

SLOTTED DRAIN

DRAIN BASIN

- SYNTHETIC TURF PLAYING FIELD CLEANOUT
- --→ SURFACE FLOW DIRECTION

SWALE

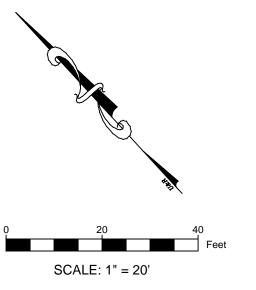





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DATE

DSA BACK	CHECK
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REV

FOOTHILL HIGH SCHOOL


ATHLETIC FIELDS

230 PALA AVENUE
San Jose, CA

SCALE:	1"=20'
DESIGNED:	BTL
DATE:	11/06/2018
DRAWN:	TML
PROJ.	18-115

DRAINAGE PLAN

DWG. NO.

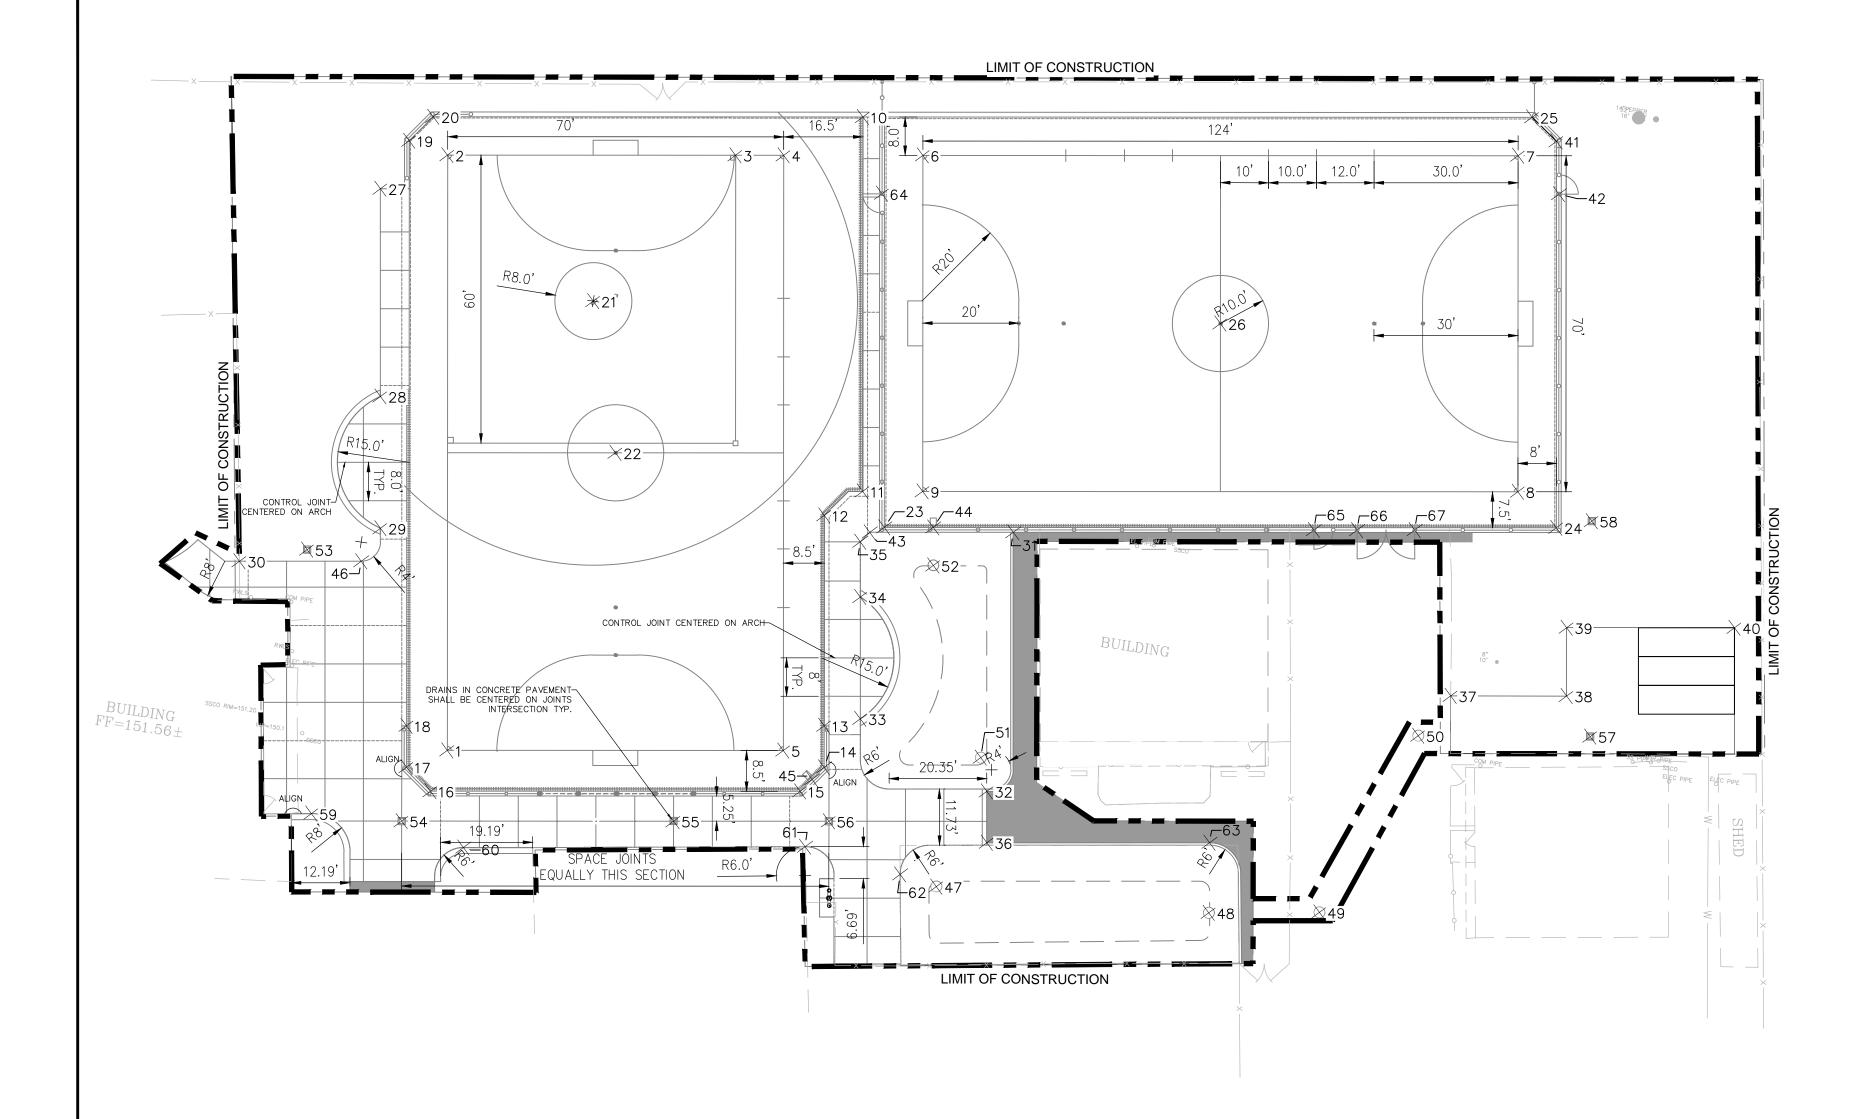

#### **DIMENSION NOTES**

- 1. THESE DIMENSIONS WERE BASED ON THE DRAWINGS PREPARED FOR THE PREVIOUS INSTALLATION. THESE ARE NOT AS—BUILTS, THE EXISTING CONDITIONS HAVE NOT BEEN SURVEYED FOR THIS PLAN SET.
- THE CONTRACTOR MUST VERIFY EXISTING DIMENSIONS PRIOR TO CONSTRUCTION.
   FUTSAL LINES MUST MEET USFF RULES AND REGULATIONS EXCEPT WHERE SPECIFICALLY
- NOTED OTHERWISE.
- 4. SOFTBALL DIMENSIONS MUST MEET NFHS RULES AND REGULATIONS EXCEPT WHERE SPECIFICALLY NOTED OTHERWISE.

		P (	oint Table
Point #	Northing	Easting	DESCRIPTION
1	5266.17	4932.04	FUTSAL FIELD CORNER
2	5388.79	4913.55	FUTSAL FIELD CORNER
3	5397.71	4972.88	SOFTBALL 3RD BASE
4	5399.20	4982.82	FUTSAL FIELD CORNER
5	5276.58	5001.26	FUTSAL FIELD CORNER
6	5403.52	5011.50	FUTSAL FIELD CORNER
7	5421.96	5134.12	FUTSAL FIELD CORNER
8	5352.74	5144.53	FUTSAL FIELD CORNER
9	5334.30	5021.91	FUTSAL FIELD CORNER
10	5409.57	4997.95	TURF EDGE
11	5332.44	5009.55	TURF EDGE
12	5326.30	5002.38	TURF EDGE
13	5282.96	5008.90	TURF EDGE
14	5274.39	5010.19	TURF EDGE
15	5268.70	5005.99	TURF EDGE
16	5257.25	4929.84	TURF EDGE
17	5261.45	4924.16	TURF EDGE
18	5269.97	4922.88	TURF EDGE
19	5390.57	4905.24	TURF EDGE
20	5396.26	4909.44	TURF EDGE
21	5363.24	4948.14	SOFTBALL PITCHING PLATE
22	5332.69	4957.43	FUTSAL MIDFIELD
23	5325.69	5015.12	TURF EDGE
24	5346.51	5153.56	TURF EDGE
25	5430.30	5135.81	TURF EDGE
26	5378.13	5078.02	FUTSAL MIDFIELD
27	5379.79	4900.80	TURF EDGE
28	5337.00	4907.25	TURF EDGE
29	5309.85	4911.35	TURF EDGE
30	5298.67	4883.35	PAVEMENT EDGE
31	5328.70	5041.82	PAVEMENT EDGE
32	5274.50	5044.44	PAVEMENT EDGE
33	5285.52	5016.12	PAVEMENT EDGE
34	5310.59	5012.34	PAVEMENT EDGE
35	5321.98	5010.62	PAVEMENT EDGE
36	5263.92	5046.03	PAVEMENT EDGE
37	5308.60	5137.03	PAVEMENT EDGE
38	5312.17	5160.92	PAVEMENT EDGE
39	5326.24	5158.80	PAVEMENT EDGE
40	5331.46	5193.37	PAVEMENT EDGE

			oint Table		
Point #	Northing	Easting	DESCRIPTION		
41	5426.11	5141.58	TURF EDGE		
42	5415.30	5143.73	CENTER OF GATE POST		
43	5324.23	5012.28	PAVEMENT EDGE		
44	5327.21	5025.22	TURF EDGE AT DRAIN		
45	5271.55	5008.09	TURF EDGE AT DRAIN		
46	5302.45	4908.42	PAVEMENT EDGE TANGENT POINT		
47	5253.33	5037.00	CLEANOUT		
48	5256.38	5093.94	ROUND STORM DRAIN		
49	5259.92	5116.72	ROUND STORM DRAIN		
50	5299.39	5131.58	ROUND STORM DRAIN		
51	5281.26	5042.15	ROUND STORM DRAIN		
52	5319.38	5026.39	CLEANOUT		
53	5303.17	4896.92	SQUARE STORM DRAIN		
54	5250.20	4924.84	SQUARE STORM DRAIN		
55	5258.62	4980.84	SQUARE STORM DRAIN		
56	5263.43	5012.85	SQUARE STORM DRAIN		
57	5304.56	5167.04	SQUARE STORM DRAIN		
58	5348.97	5160.65	SQUARE STORM DRAIN		
59	5248.92	4906.00	PAVEMENT EDGE TANGENT POINT		
60	5246.66	4938.37	PAVEMENT EDGE TANGENT POINT		
61	5257.46	5008.72	PAVEMENT EDGE TANGENT POINT		
62	5254.72	5029.17	PAVEMENT EDGE TANGENT POINT		
63	5270.85	5091.92	PAVEMENT EDGE TANGENT POINT		
64	5394.34	5004.29	CENTER OF GATE POST		
65	5338.51	5103.69	CENTER OF GATE POST		
66	5339.84	5112.59	CENTER OF GATE POST		
67	5341.63	5124.46	CENTER OF GATE POST		





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DSA BACK CHECK

REV.

FOOTHILL HIGH SCHOOL ATHLETIC FIELDS 230 PALA AVENUE San Jose, CA

SCALE: 1"=20'
DESIGNED: BTL

DATE: 11/06/2018


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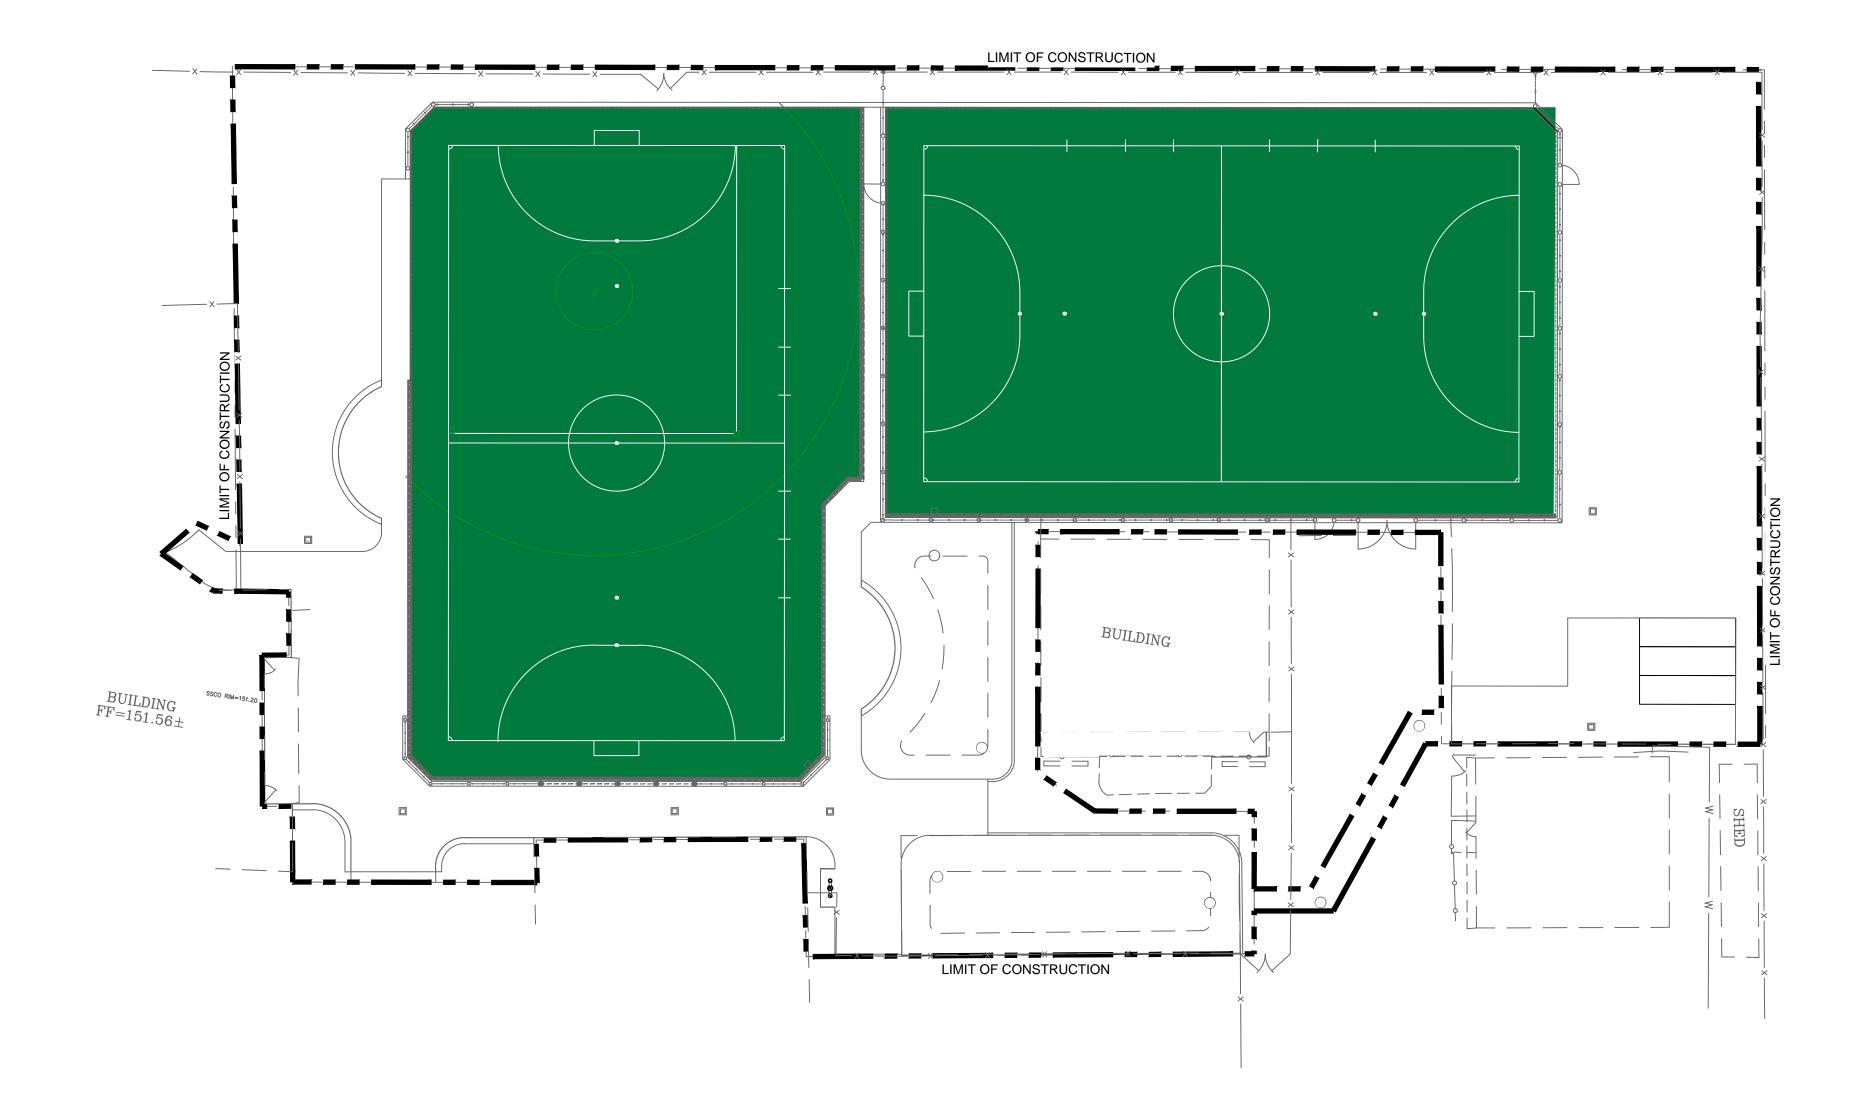
PROJ. 18-115

APPROVED:

**DIMENSION PLAN** 

DWG. NO.



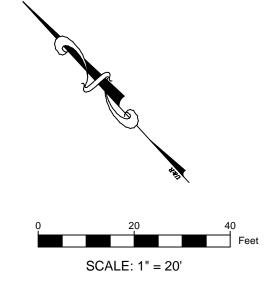

# COLOR GRAPHICS NOTES:

- 1. THIS GRAPHICS PLAN IS FOR REFERENCE ONLY. THE TURF MANUFACTURER AND
- INSTALLER MUST SUBMIT FOR REVIEW SHOP DRAWINGS PER SPECIFICATIONS.

  2. ALL LINE WORK MUST BE IN ACCORDANCE WITH NFHS RULES AND REGULATIONS FOR
- SOFTBALL AS WELL AS USFF RULES AND REGULATIONS FOR FUTSAL.
- 3. FUTSAL IS TO BE THE DOMINATE LINE COLOR OVER SOFTBALL.
- 4. COLOR SELECTION IS TO BE FINALIZED DURING SHOP DRAWING SUBMITTAL REVIEW
- 5. TURF MAY NOT BE PURCHASED UNTIL SHOP DRAWINGS AND PHYSICAL SAMPLES ARE APPROVED IN WRITING BY THE OWNER.

# COLOR GRAPHICS LEGEND



SYNTHETIC TURF COLOR GREEN FUTSAL STRIPING COLOR WHITE SOFTBALL STRIPING COLOR LIGHT GREEN



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SUITE 515-324 SCOTTSDALE, ARIZONA 85258 PH 602.635.4226

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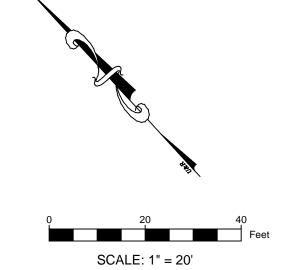
FOOTHILL HIGH SCHOOL ATHLETIC FIELDS 230 PALA AVENUE


San Jose, CA

SCALE: 1"=20' DESIGNED: BTL DATE: 11/06/2018 DRAWN: BTL

PROJ. 18-115 APPROVED:

> COLOR **GRAPHICS PLAN** DWG. NO.



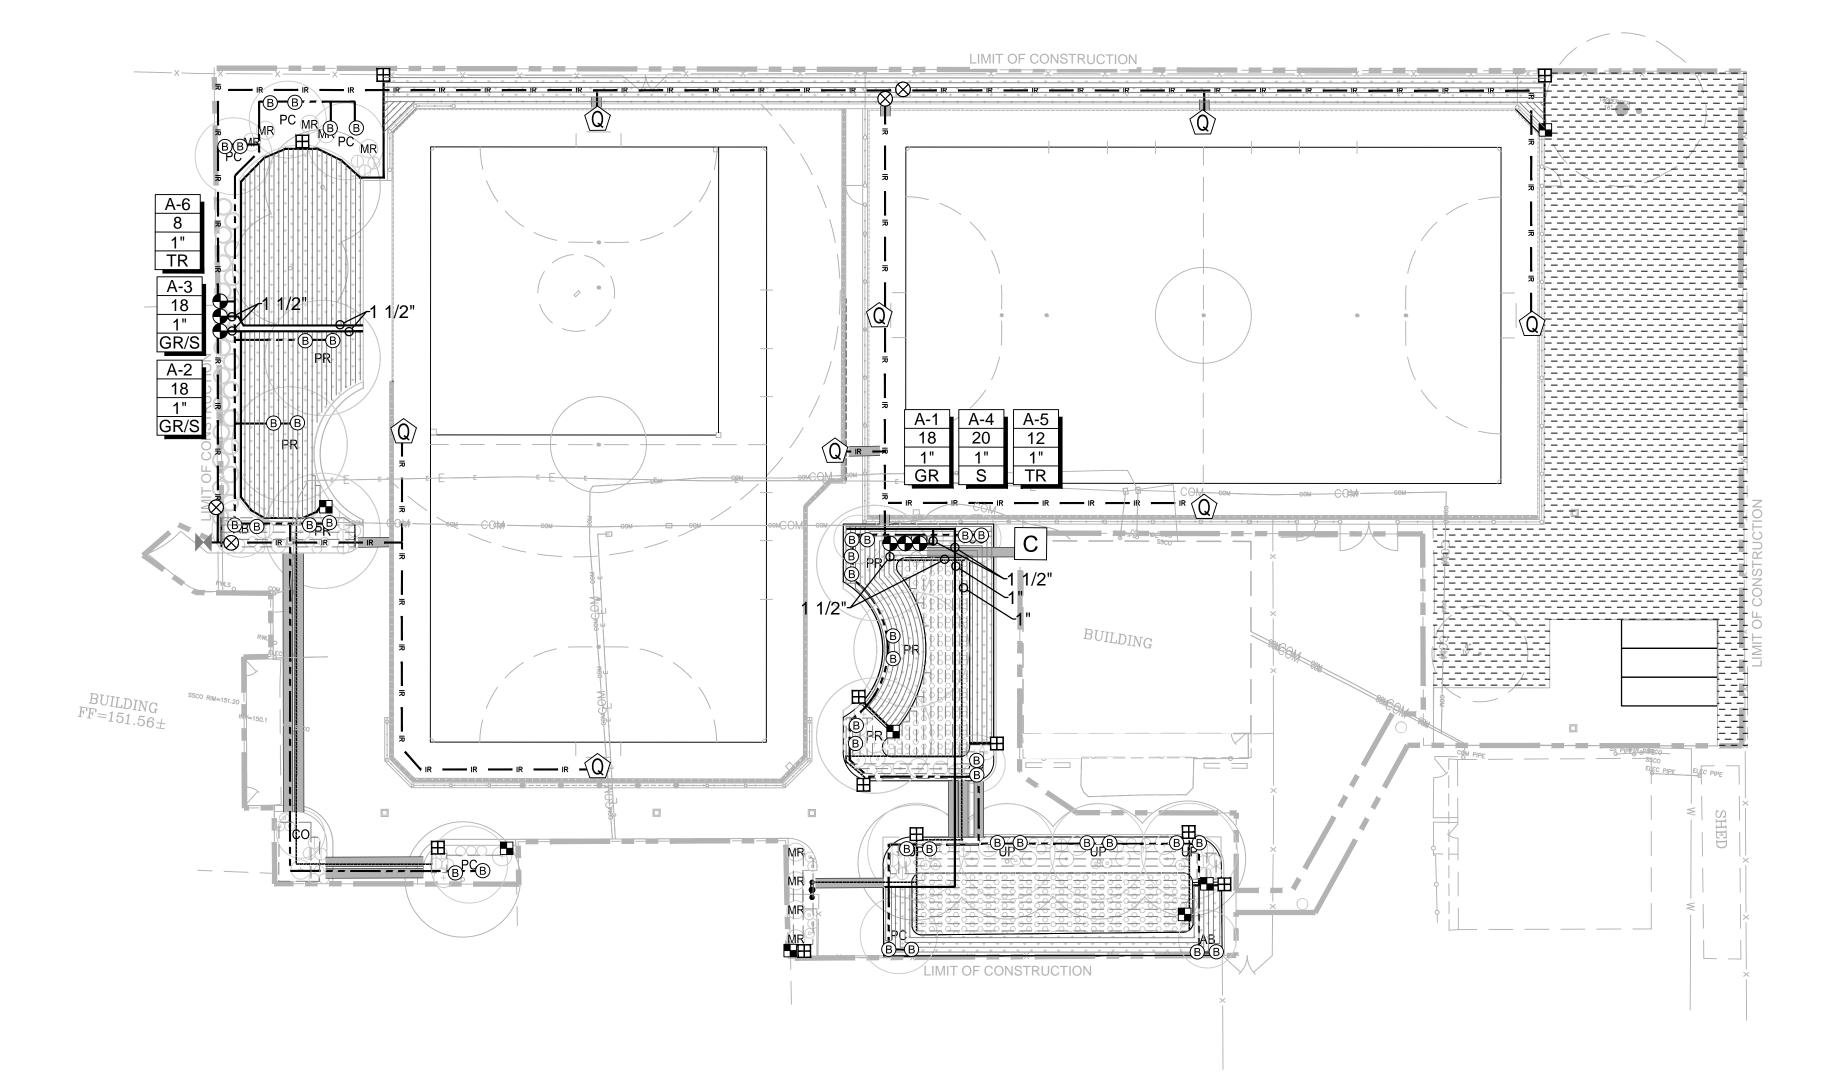

#### **IRRIGATION EQUIPMENT LEGEND:**

- CONNECT TO EXISTING IRRIGATION MAINLINE
- IR IRRIGATION MAINLINE (2" EXCEPT WHERE NOTED OTHERWISE) 2" SOLVENT WELD CLASS 200 PVC W/ SCH 80 FITTINGS
  - ISOLATION GATE VALVE (SIZE TO MATCH MAINLINE)
  - NIBCO T113-K
  - QUICK COUPLER VALVE (1" SIZE) RAINBIRD 44-RC IN SYNTHETIC TURF COMBOX
- → DRIP REMOTE CONTROL VALVE RAINBIRD 1" PEB VALVE W/ 1" PRB-QKCHK PRESSURE REGULATING BASKET W/ BRONZE ISOLATION BALL VALVE WITH SS HANDLE W/ SCH 80 PVC UNION


PLAYING FIELD REMOTE CONTROL VALVE DESIGNATOR

─ CONTROLLER — STATION NUMBER FLOW RATE (GPM)

- VALVE SIZE (INCH) ZONE TYPE (GR=GRASS DRIP/S=SHRUB DRIP/TR=TREE BUBBLER)
- C NEW IRRIGATION CONTROLLER
  TORO SENTINEL TS12WS1U2 WITH CELLULAR COMMUNICATION OPTIONS PROVIDE SHHR SENTINEL HAND HELD REMOTE
- SLEEVE PIPE 2X NOMINAL SIZE OF CARRIER PIPE INSTALL BELOW ALL HARDSCAPE CROSSINGS INSTALL CONTROL WIRE BUNDLE IN 3" WHERE NOT INSTALLED IN MAINLINE TRENCH
- ——— GRASS DRIP PVC LATERAL/ HEADER / FOOTER (1" EXCEPT WHERE NOTED OTHERWISE) SCH 40 PVC W/ SOLVENT WELD SCH 40 FITTINGS
  - GRASS INLINE DRIP TUBING RAINBIRD XFS-CV-09-12 SPACED AT 12" O.C.
- SHRUB DRIP PVC LATERAL/ HEADER / FOOTER (1" EXCEPT WHERE NOTED OTHERWISE) SCH 40 PVC W/ SOLVENT WELD SCH 40 FITTINGS
- \_\_\_\_ SHRUB INLINE DRIP TUBING RAINBIRD XFS-CV-09-12 SPACED AT 12" O.C.
- DRIP LATERAL FLUSH VALVE PER DETAIL
- AIR RELIEF VALVE PER DETAIL
- - TREE BUBBLE PVC LATERAL (1" EXCEPT WHERE NOTED OTHERWISE) SCH 40 PVC W/ SOLVENT WELD SCH 40 FITTINGS
- TREE BUBBLERS RAINBIRD RWS-M-B-C-1402 (2 PER TREE)

#### **IRRIGATION NOTES:**

- 1. CONNECT TO EXISTING MAINLINE THE EXISTING POINT OF CONNECTION LOCATION, FLOW, AND PRESSURE MUST BE VERIFIED BY CONTRACTOR PRIOR TO CONSTRUCTION. IF PRESSURE IS LESS THAN 50 PSI AT 40GPM NOTIFY ENGINEER IMMEDIATELY.
- 2. REFER TO SPECIFICATIONS FOR ALL PRESSURE TESTING AND FLUSHING REQUIREMENTS. 3. COORDINATE CONTROLLER POWER WITH EXISTING ELECTRICAL POWER SUPPLY. ALL 120 POWER CONNECTIONS TO BE PERFORMED BY LICENSED ELECTRICAL CONTRACTOR.
- 4. COORDINATE LOCATION OF RAIN SENSOR INSTALLATION WITH OWNER.
- 5. CONTROLLER TO BE GROUND PER MANUFACTURER'S REQUIREMENTS.
- 6. ALL CONTROL AND SIGNAL WIRES MUST BE SPLICED IN DEDICATED 10" ROUND VALVE
- 7. INSTALL A MINIMUM OF (3) CONTROL AND (1) COMMON SPARES TO LAST CONTROL VALVE ON ALL MAINLINE LEGS.
- 8. ALL IRRIGATION VALVE AND PIPE SYMBOL LOCATIONS ARE DIAGRAMMATIC. DO NOT INSTALL IRRIGATION EQUIPMENT IN DIRECT CONFLICT WITH UTILITY, LANDSCAPE, OR HARDSCAPE ELEMENTS. COORDINATE LOCATION OF ALL NEW AND EXISTING UTILITIES PRIOR TO IRRIGATION INSTALLATION. CONTACT ENGINEER IMMEDIATELY IF CONFLICTS ARE
- 9. DO NOT CROSS CONNECT GRASS DRIP LINES WITH SHRUB DRIP LINES EXCEPT WHERE SPECIFICALLY INDICATED TO DO SO ON VALVE #A-3.
- 10. COORDINATE MAINLINE RETAINING WALL PENETRATIONS WITH HARDSCAPE CONTRACTOR PRIOR TO CONSTRUCTION. SLEEVES ARE REQUIRED FOR PIPE AND WIRE.
- 11. EXISTING UTILITIES SHOWN ARE FOR REFERENCE ONLY. ADDITIONAL UTILITIES MAY BE PRESENT. CONTRACTOR MUST UTILIZE UTILITY LOCATION SERVICE PRIOR TO CONSTRUCTION AND TRENCH WITH CAUTION. CONTRACTOR IS RESPONSIBLE TO REPAIR OR REPLACE ANY UTILITIES DAMAGED DURING CONSTRUCTION.
- 12. CONTRACTOR MUST COORDINATE CONTROLLER INSTALLATION AND CONNECTION TO DISTRICT CENTRAL CONTROL COMMUNICATION AND PROGRAMMING PRIOR TO CONSTRUCTION.

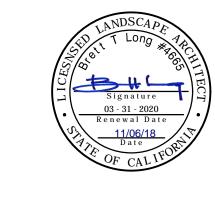

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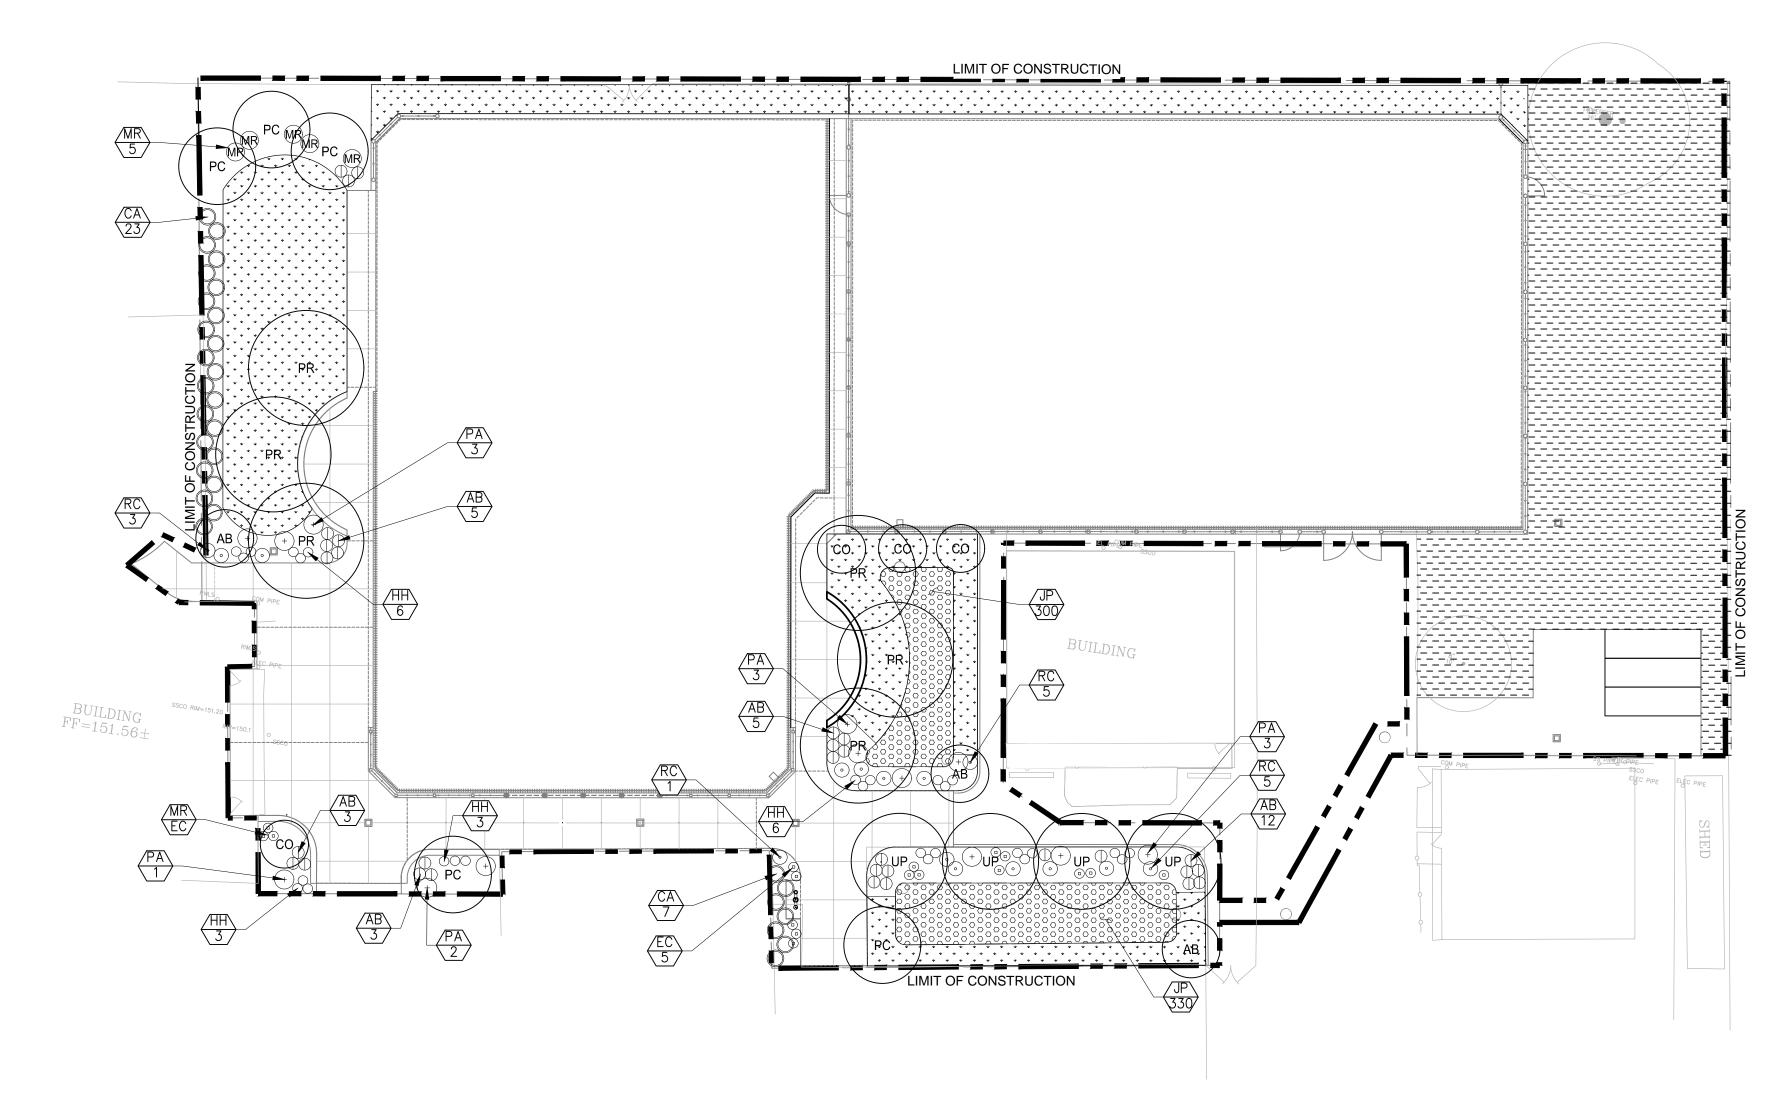
FOOTHILL HIGH SCHOOL ATHLETIC FIELDS 230 PALA AVENUE

San Jose, CA SCALE: 1"=20' DESIGNED: BTL 11/06/2018 DATE: DRAWN: ZT PROJ. 18-115

IRRIGATION PLAN

APPROVED:

DWG. NO.



# PLANT KEY


CO <i>Cerc</i> PR <i>Plat</i>	uts 'Marina' cis occidentalis	Strawberry Tree Redbud	36" BOX 24" BOX	PER PLAN	
CO <i>Cerc</i> PR <i>Plat</i>	cis occidentalis	•			
PR Plat		Redbud	24" DOV		
			24 BUX	PER PLAN	MULTI TRUNK
	anus racemosa	California Sycamore	36" BOX	PER PLAN	
PC Prur	nus cerasifera 'Krauter Vesuvius'	Purple Leaf Plum	36" BOX	PER PLAN	
UP <i>Ulm</i>	nus parvifolia	Chinese Elm	36" BOX	PER PLAN	
_	magrastis 'Karl Foester'	Feather Reed Grass	5 GALLON	PER PLAN	
SHRUBS & PEREN AB Ania	gozanthos 'Big Red'	Big Red Kagaroo Paw	5 GALLON	PER PLAN	
	=				
•	obium canum	California Fuscia	1 GALLON	PER PLAN	
RC Rose	a californica	California Wild Rose	5 GALLON	PER PLAN	
MR Muh	hlenbergia rigens	Deer Grass	5 GALLON	PER PLAN	
	rovskia atriplicifolia	Russian Sage	1 GALLON	PER PLAN	
PA Petr	ον εκτά αιτηρική στια				

#### PLANTING NOTES:


- CONTRACTOR SHALL PROTECT AND MAINTAIN ALL DELIVERED PLANT MATERIAL UNTIL FINAL ACCEPTANCE. THE OWNER SHALL NOT BE RESPONSIBLE FOR LOSSES DUE TO EXPOSURE, DAMAGE, THEFT, VANDALISM OR SEVERE WEATHER.
- 2. CONTRACTOR SHALL INSTALL PLANT MATERIALS SUCH THAT THEY DO NOT INTERFERE WITH THE IRRIGATION SYSTEM OR INHIBIT THE REQUIRED COVERAGE. PLANT LOCATIONS MAY BE ADJUSTED TO ACCOMMODATE SITE CONDITIONS SO LONG AS THEY MEET THE APPROVAL OF THE LANDSCAPE ARCHITECT AND THE DESIGN INTENT.
- 3. CONTRACTOR SHALL GIVE THE LANDSCAPE ARCHITECT 2 WORKING DAYS NOTICE PRIOR TO INSTALLATION OF PLANTS FOR REVIEW OF DELIVERED AND STAGED PLANT MATERIALS AND PREPARED FINISHED GRADES. CONTRACTOR SHALL AMEND AND PREPARE PLANTING BEDS TO FINISHED GRADE PER THE PLANS AND SPECIFICATIONS PRIOR TO INSTALLATION FOR REVIEW BY THE LANDSCAPE ARCHITECT PRIOR TO INSTALLATION OF PLANT MATERIAL.
- 4. ALL SHRUB AND PERENNIAL BEDS SHALL RECEIVE 3—INCHES OF MULCH PER THE PLANS AND SPECIFICATIONS.
- 5. BIORETENTION BEDS SHALL NOT RECEIVE WOOD CHIP, BARK OR MUCH THAT MAY FLOAT WITH BASIS ARE FULL.
- 6. ALL TURF, MULCH AND PLANTING BEDS SHALL RECEIVE SOIL AMENDMENTS AND PREPARATION PER THE SPECIFICATIONS UNLESS OTHERWISE NOTED.
- 7. PLANTING COUNTS ARE FOR BIDDING DESIGN REFERENCE. CONTRACTOR SHALL SUPPLY ALL PLANTS REQUIRED TO MEET IDENTIFIED SPACING AND DESIGN INTENT AS SHOWN ON THE PLANS.

# PLANTING LEGEND

NO-MOW TURF SOD

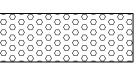


BIORETENTION PLANTING, REFER TO KEY LIST & SPACING DETAIL FOR PLANT LAYOUT AND SPACING.

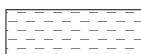

MULCH AREA THAT DOES NOT RECEIVE PLANTING & IRRIGATION



IRRIGATION

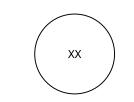

TREE SYMBOL TYPICAL KEY NOTE LABEL APPROXIMATE CANOPY AT 5 YEAR GROWTH REFER TO DETAIL 01, SHEET PF-10.5



SHRUB, PERENNIAL AND GROUND COVER SYMBOL TYPICAL REFER TO DETAIL 02, SHEET PF-10.5



PLANT CALLOUT W/ KEY NOTE AND QUANTITY, REFER TO PLANT KEY LIST



7349 N. VIA PASEO DEL SUR

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# DSA BACK CHECK

RE

#### FOOTHILL HIGH SCHOOL ATHLETIC FIELDS 230 PALA AVENUE

San Jose, CA

SCALE: 1"=20'

DESIGNED: BTL

DATE: 11/06/2018


DRAWN: BTL
PROJ. 18-115

APPROVED:


PLANTING PLAN


DWG. NO.


PF-09

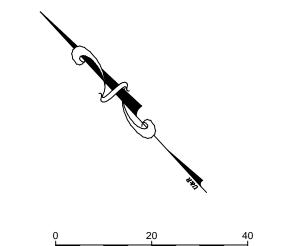

SCALE: 1" = 20'

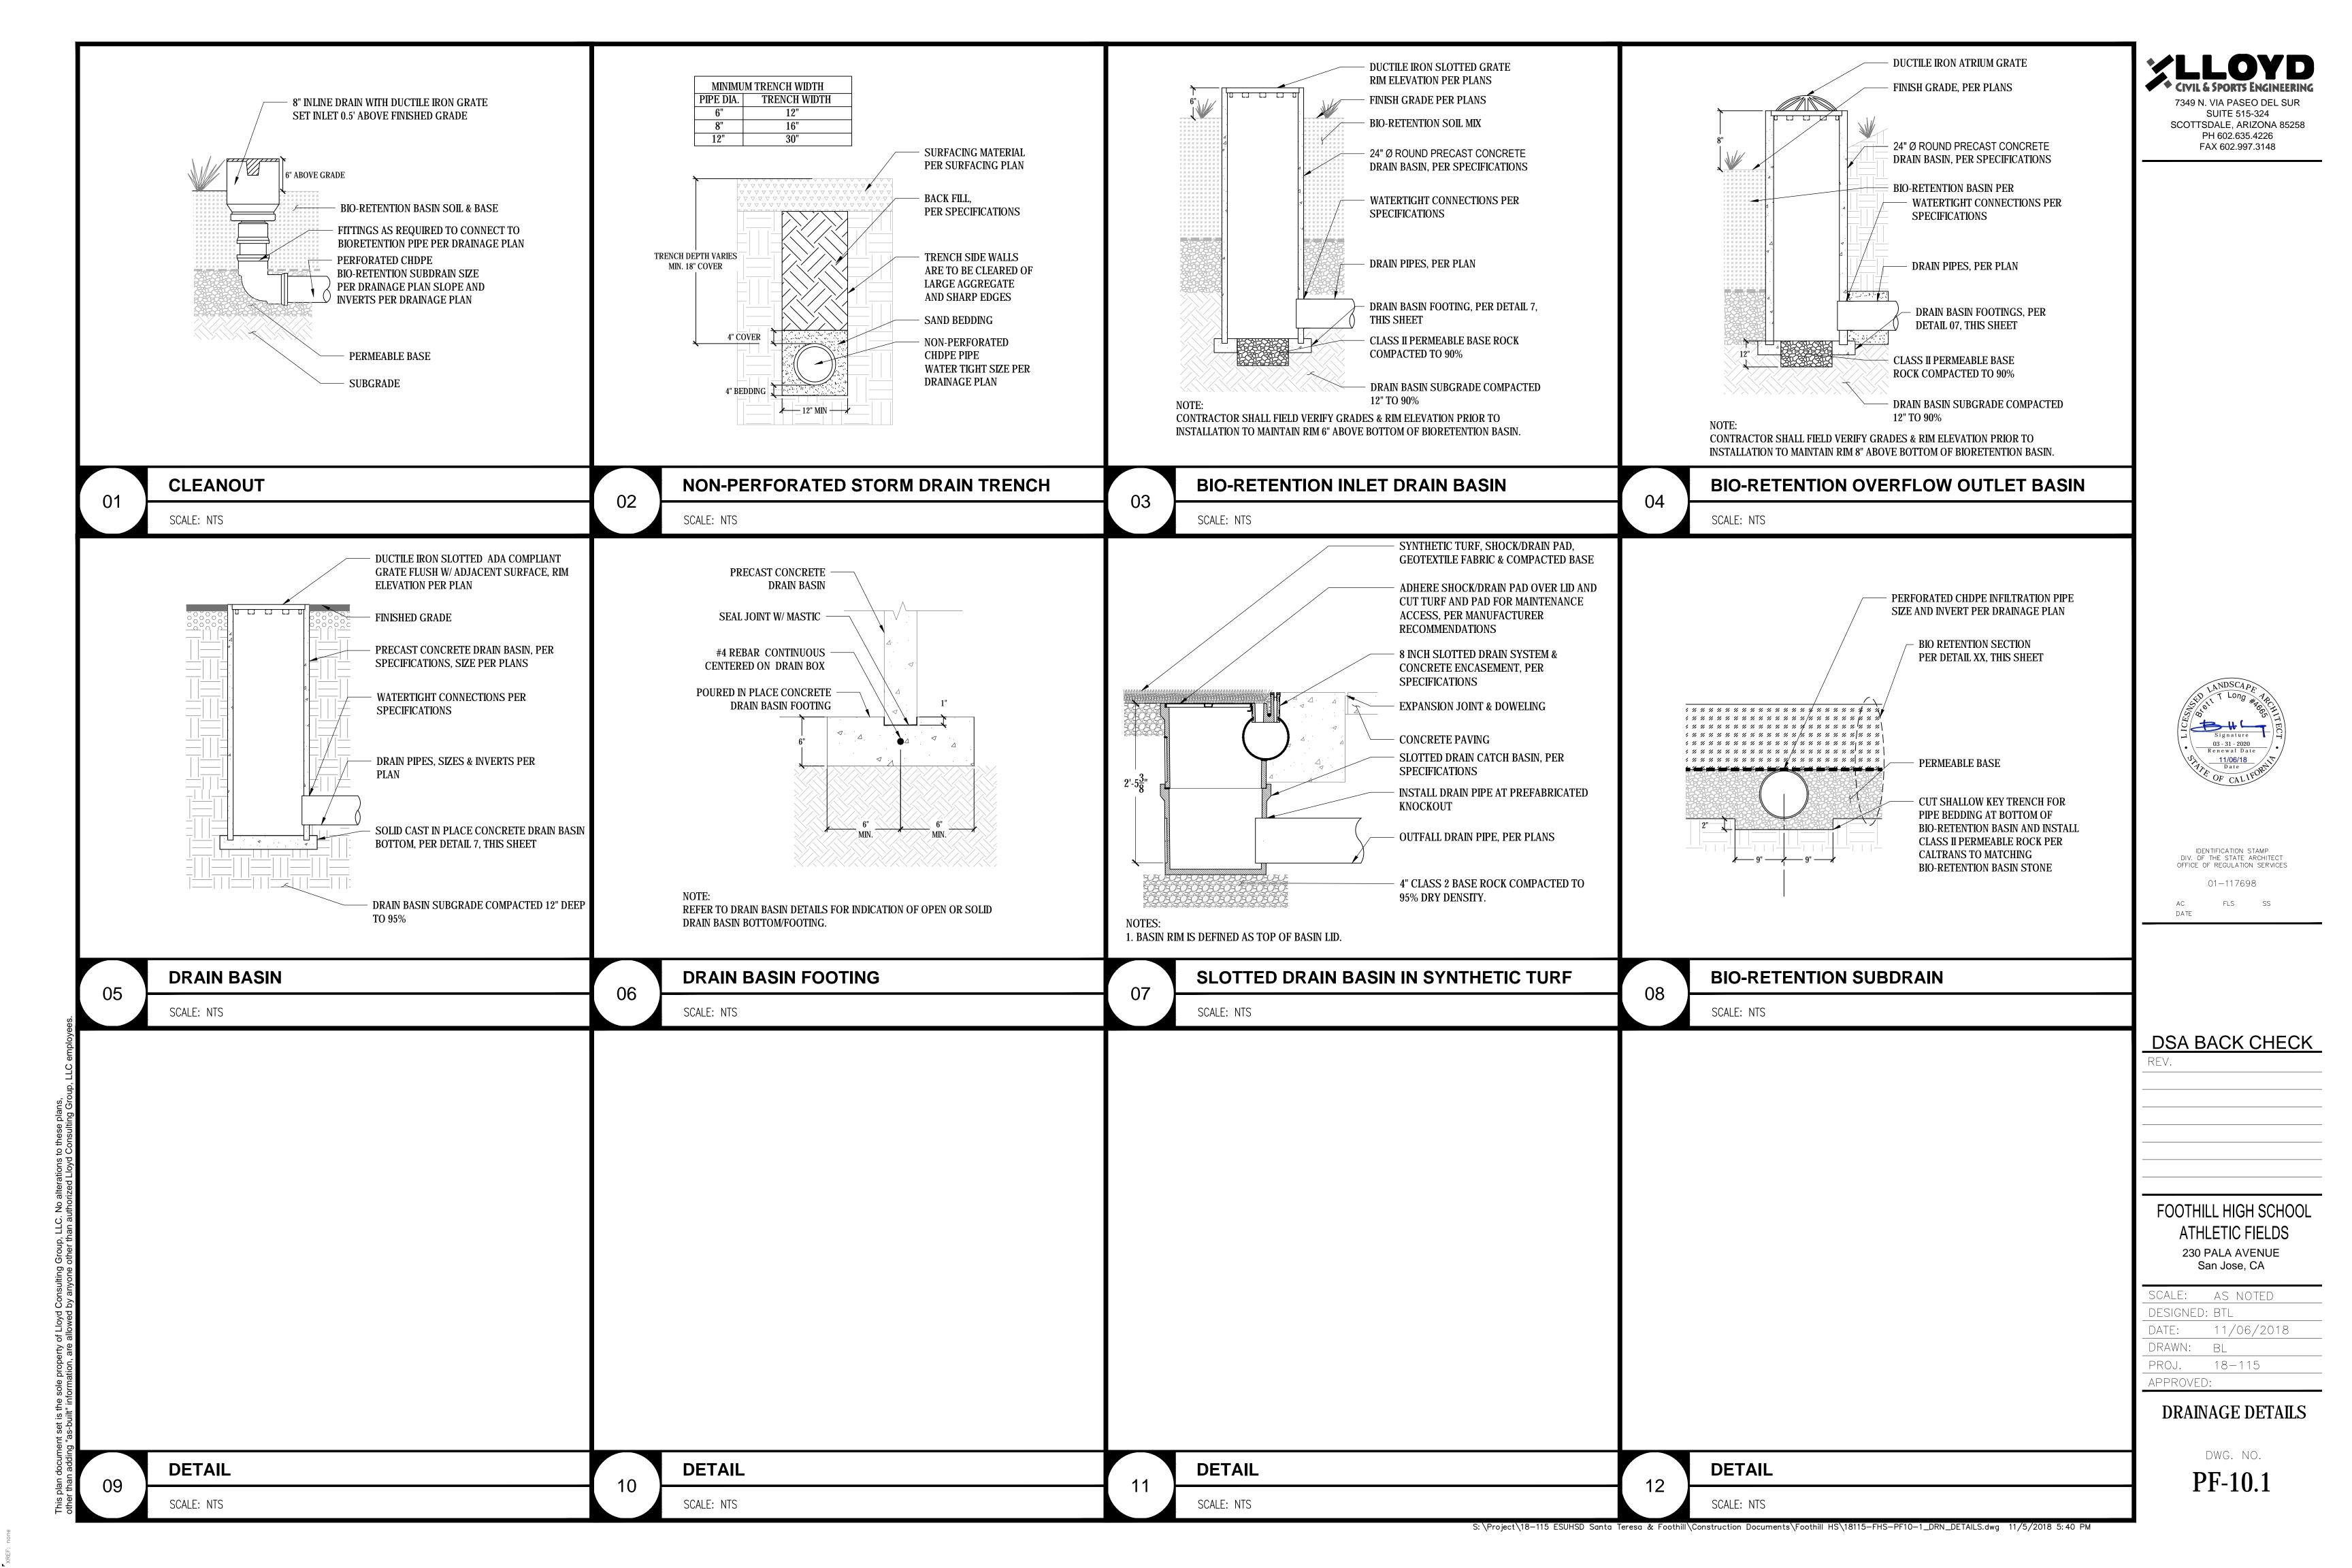

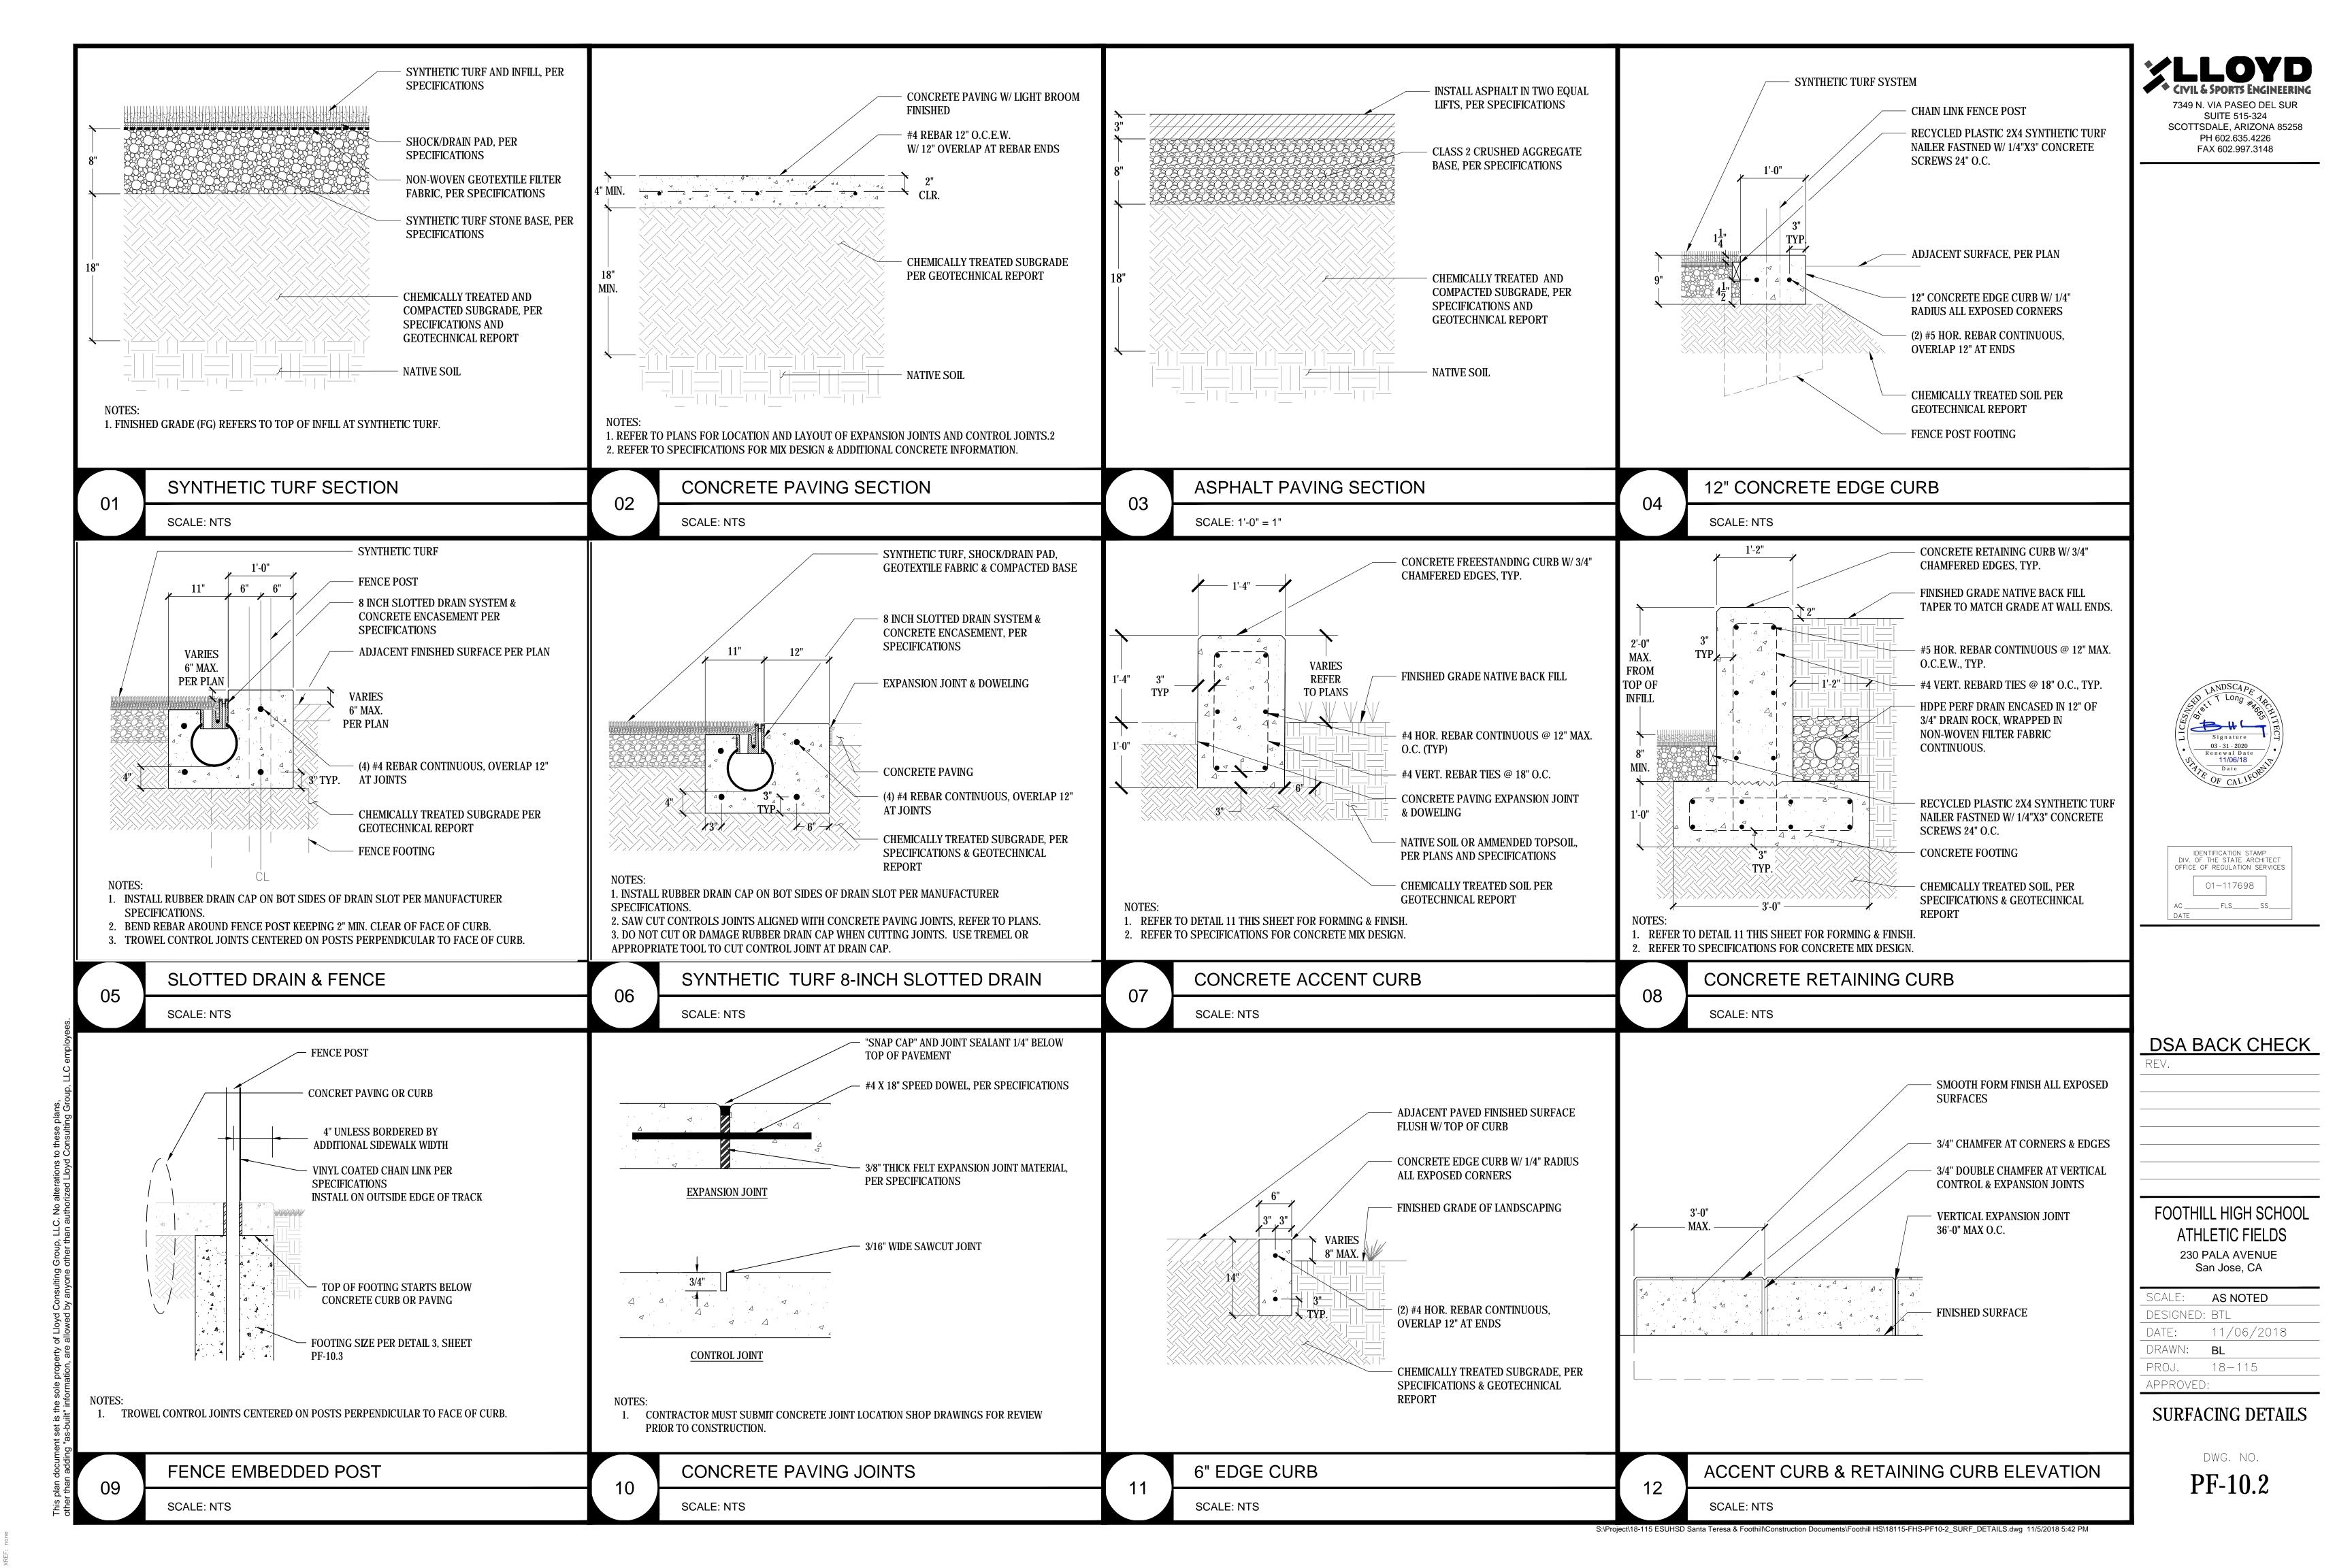

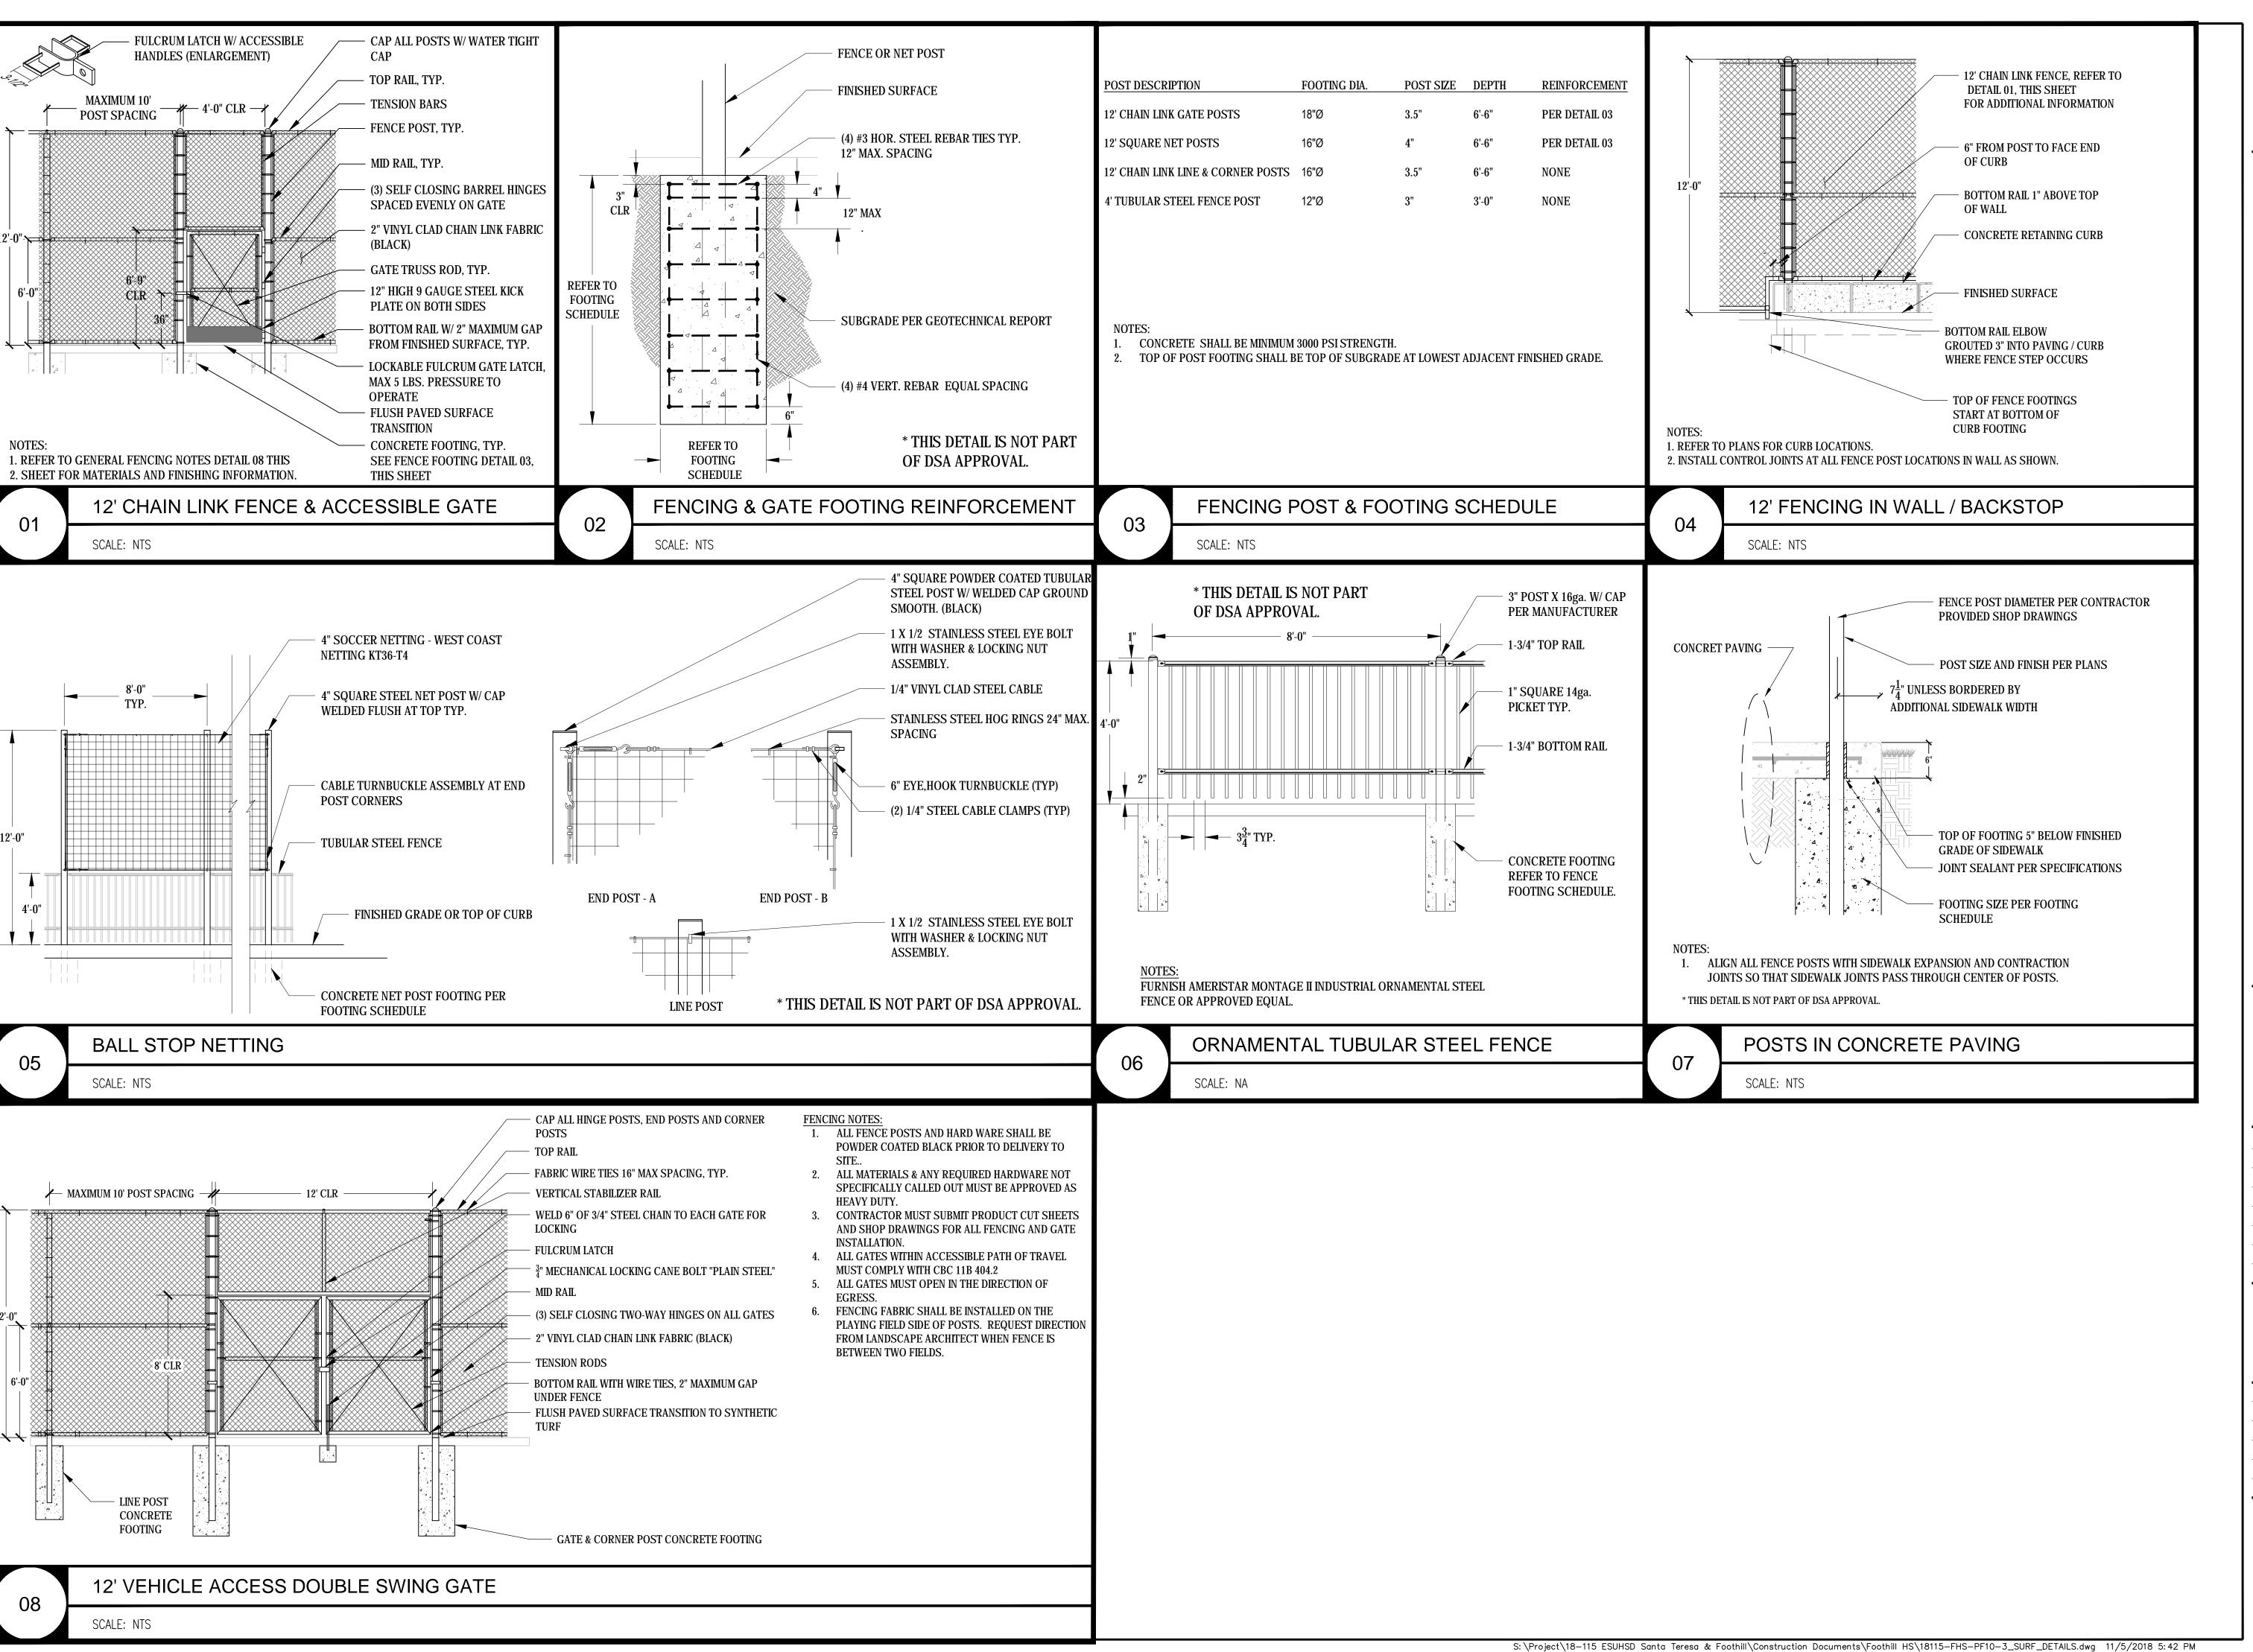

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DATE

FLS SS

DSA BACK CHECK

FOOTHILL HIGH SCHOOL ATHLETIC FIELDS 230 PALA AVENUE

San Jose, CA SCALE: AS NOTED


DESIGNED: BTL DATE: 11/06/2018 DRAWN: BL PROJ. 18-115


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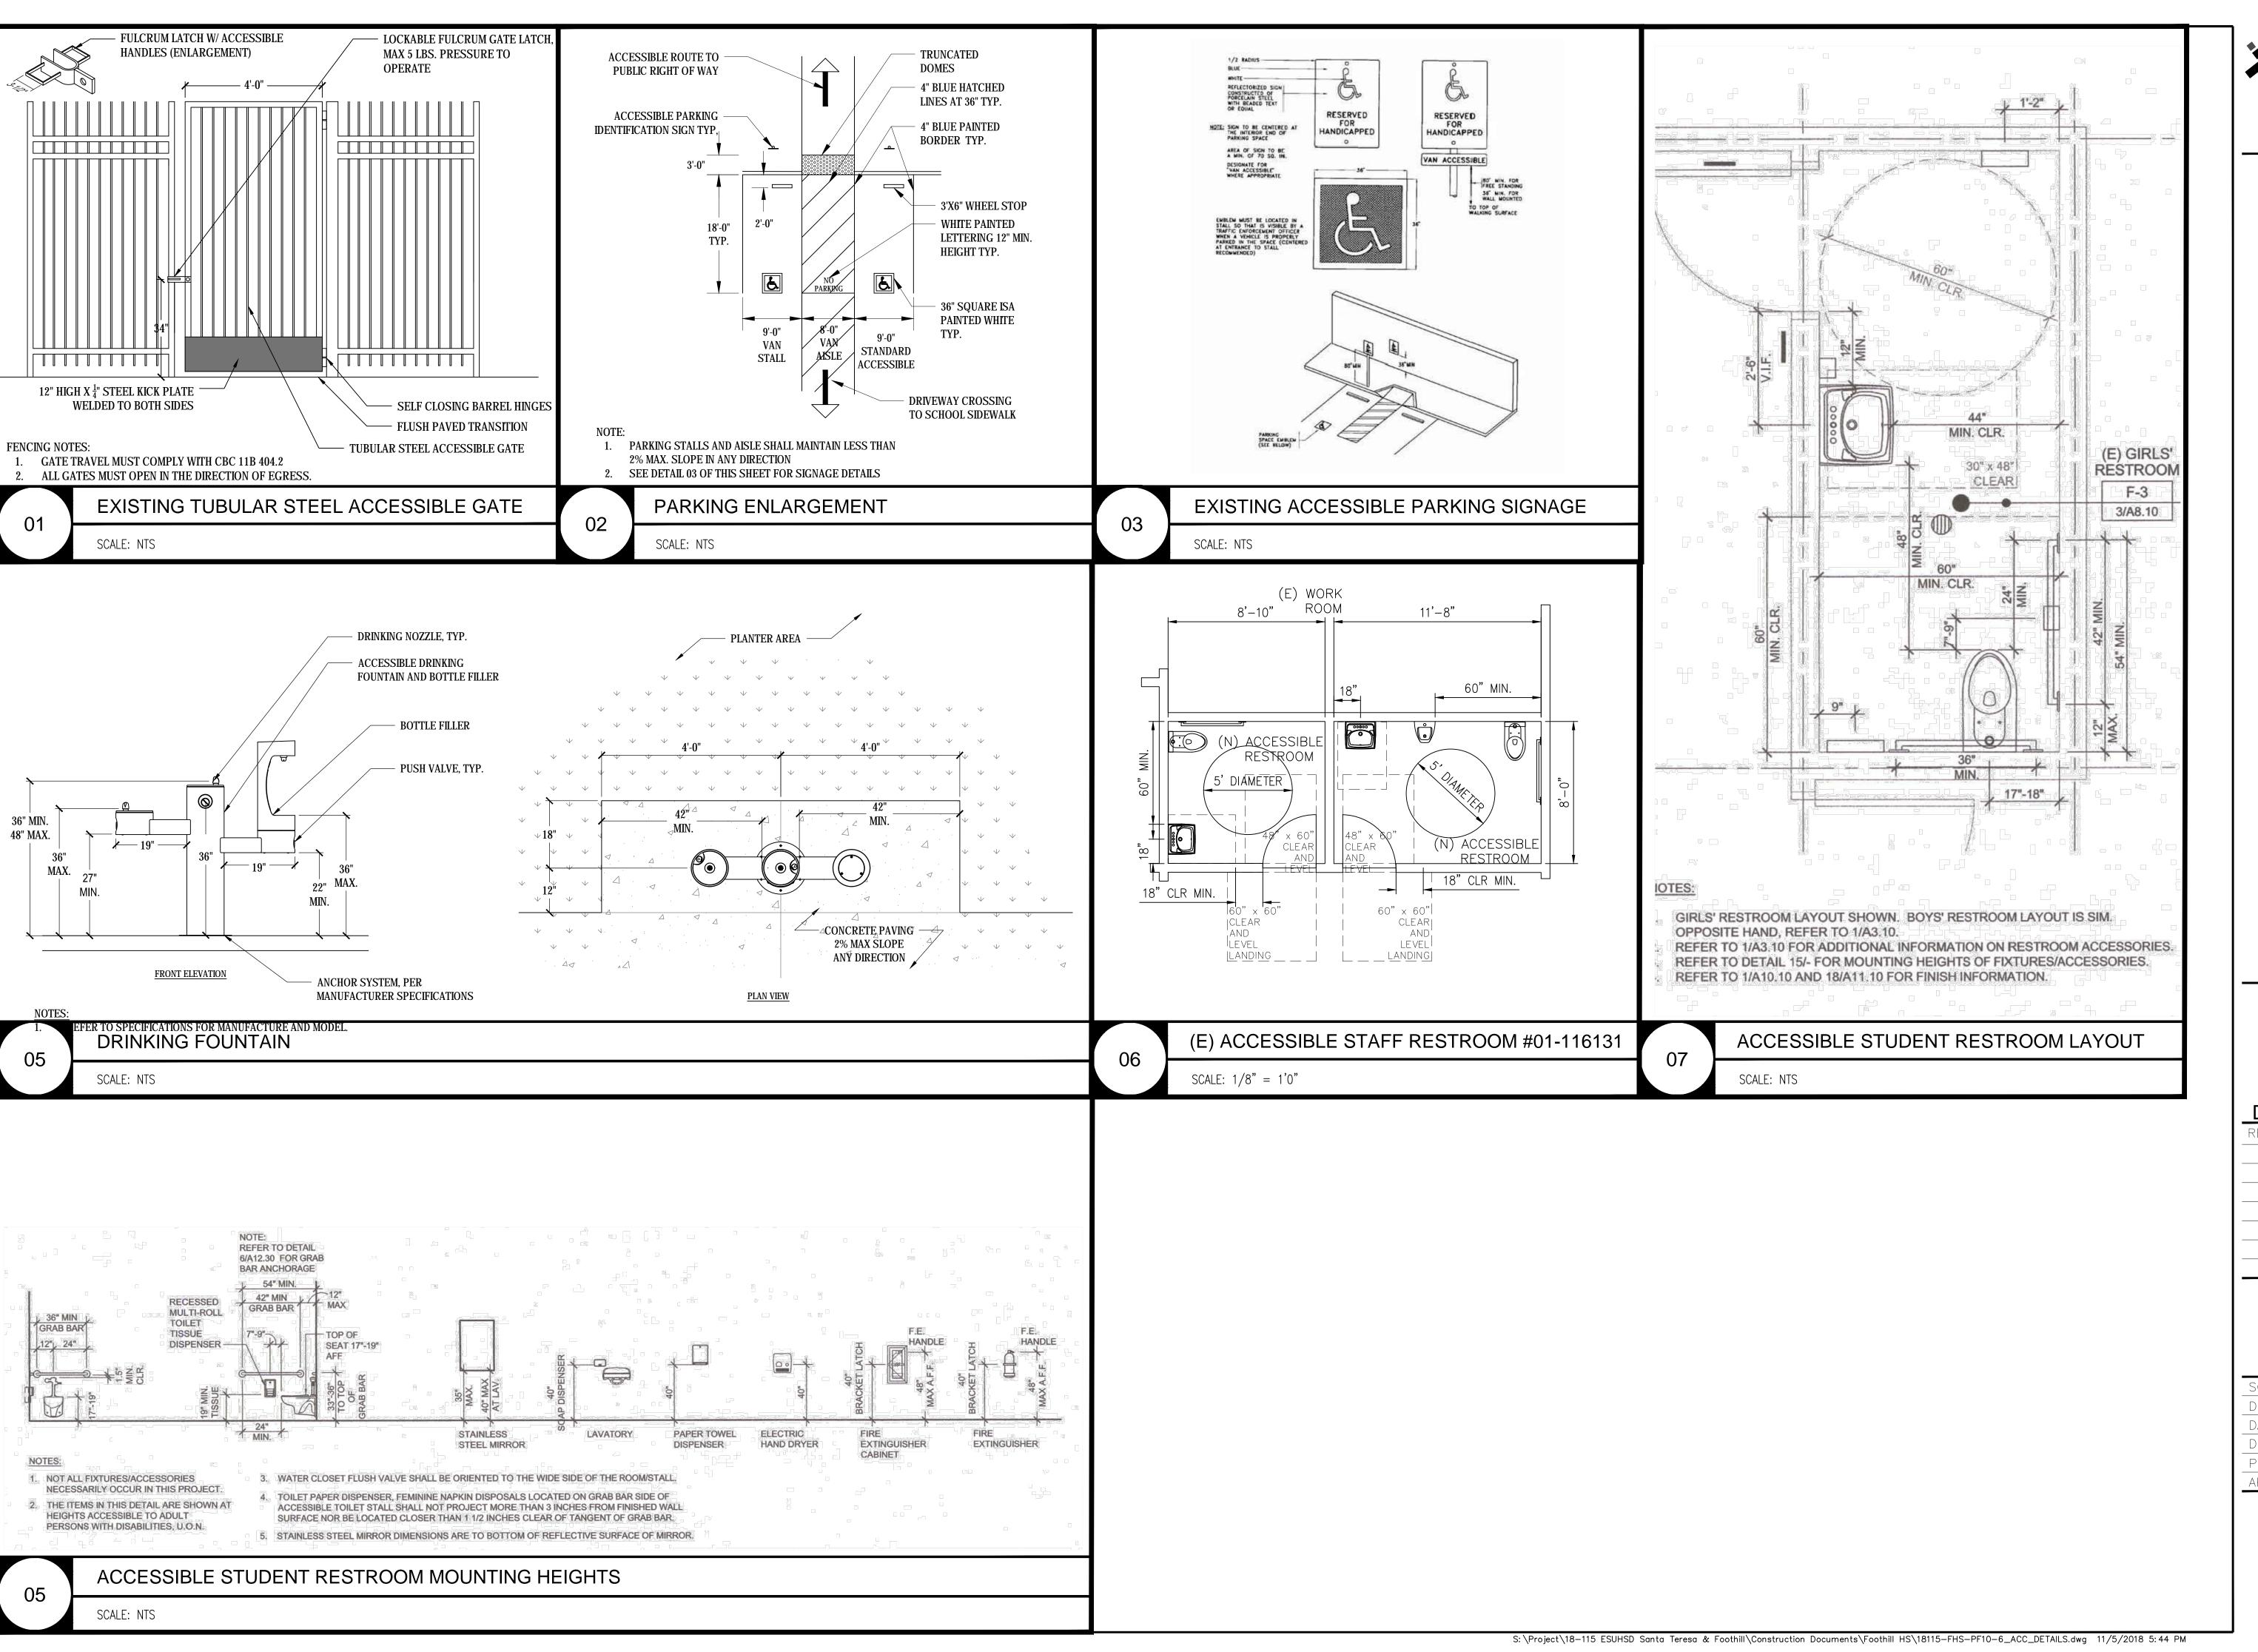
SURFACING DETAILS

DWG. NO.

PF-10.3



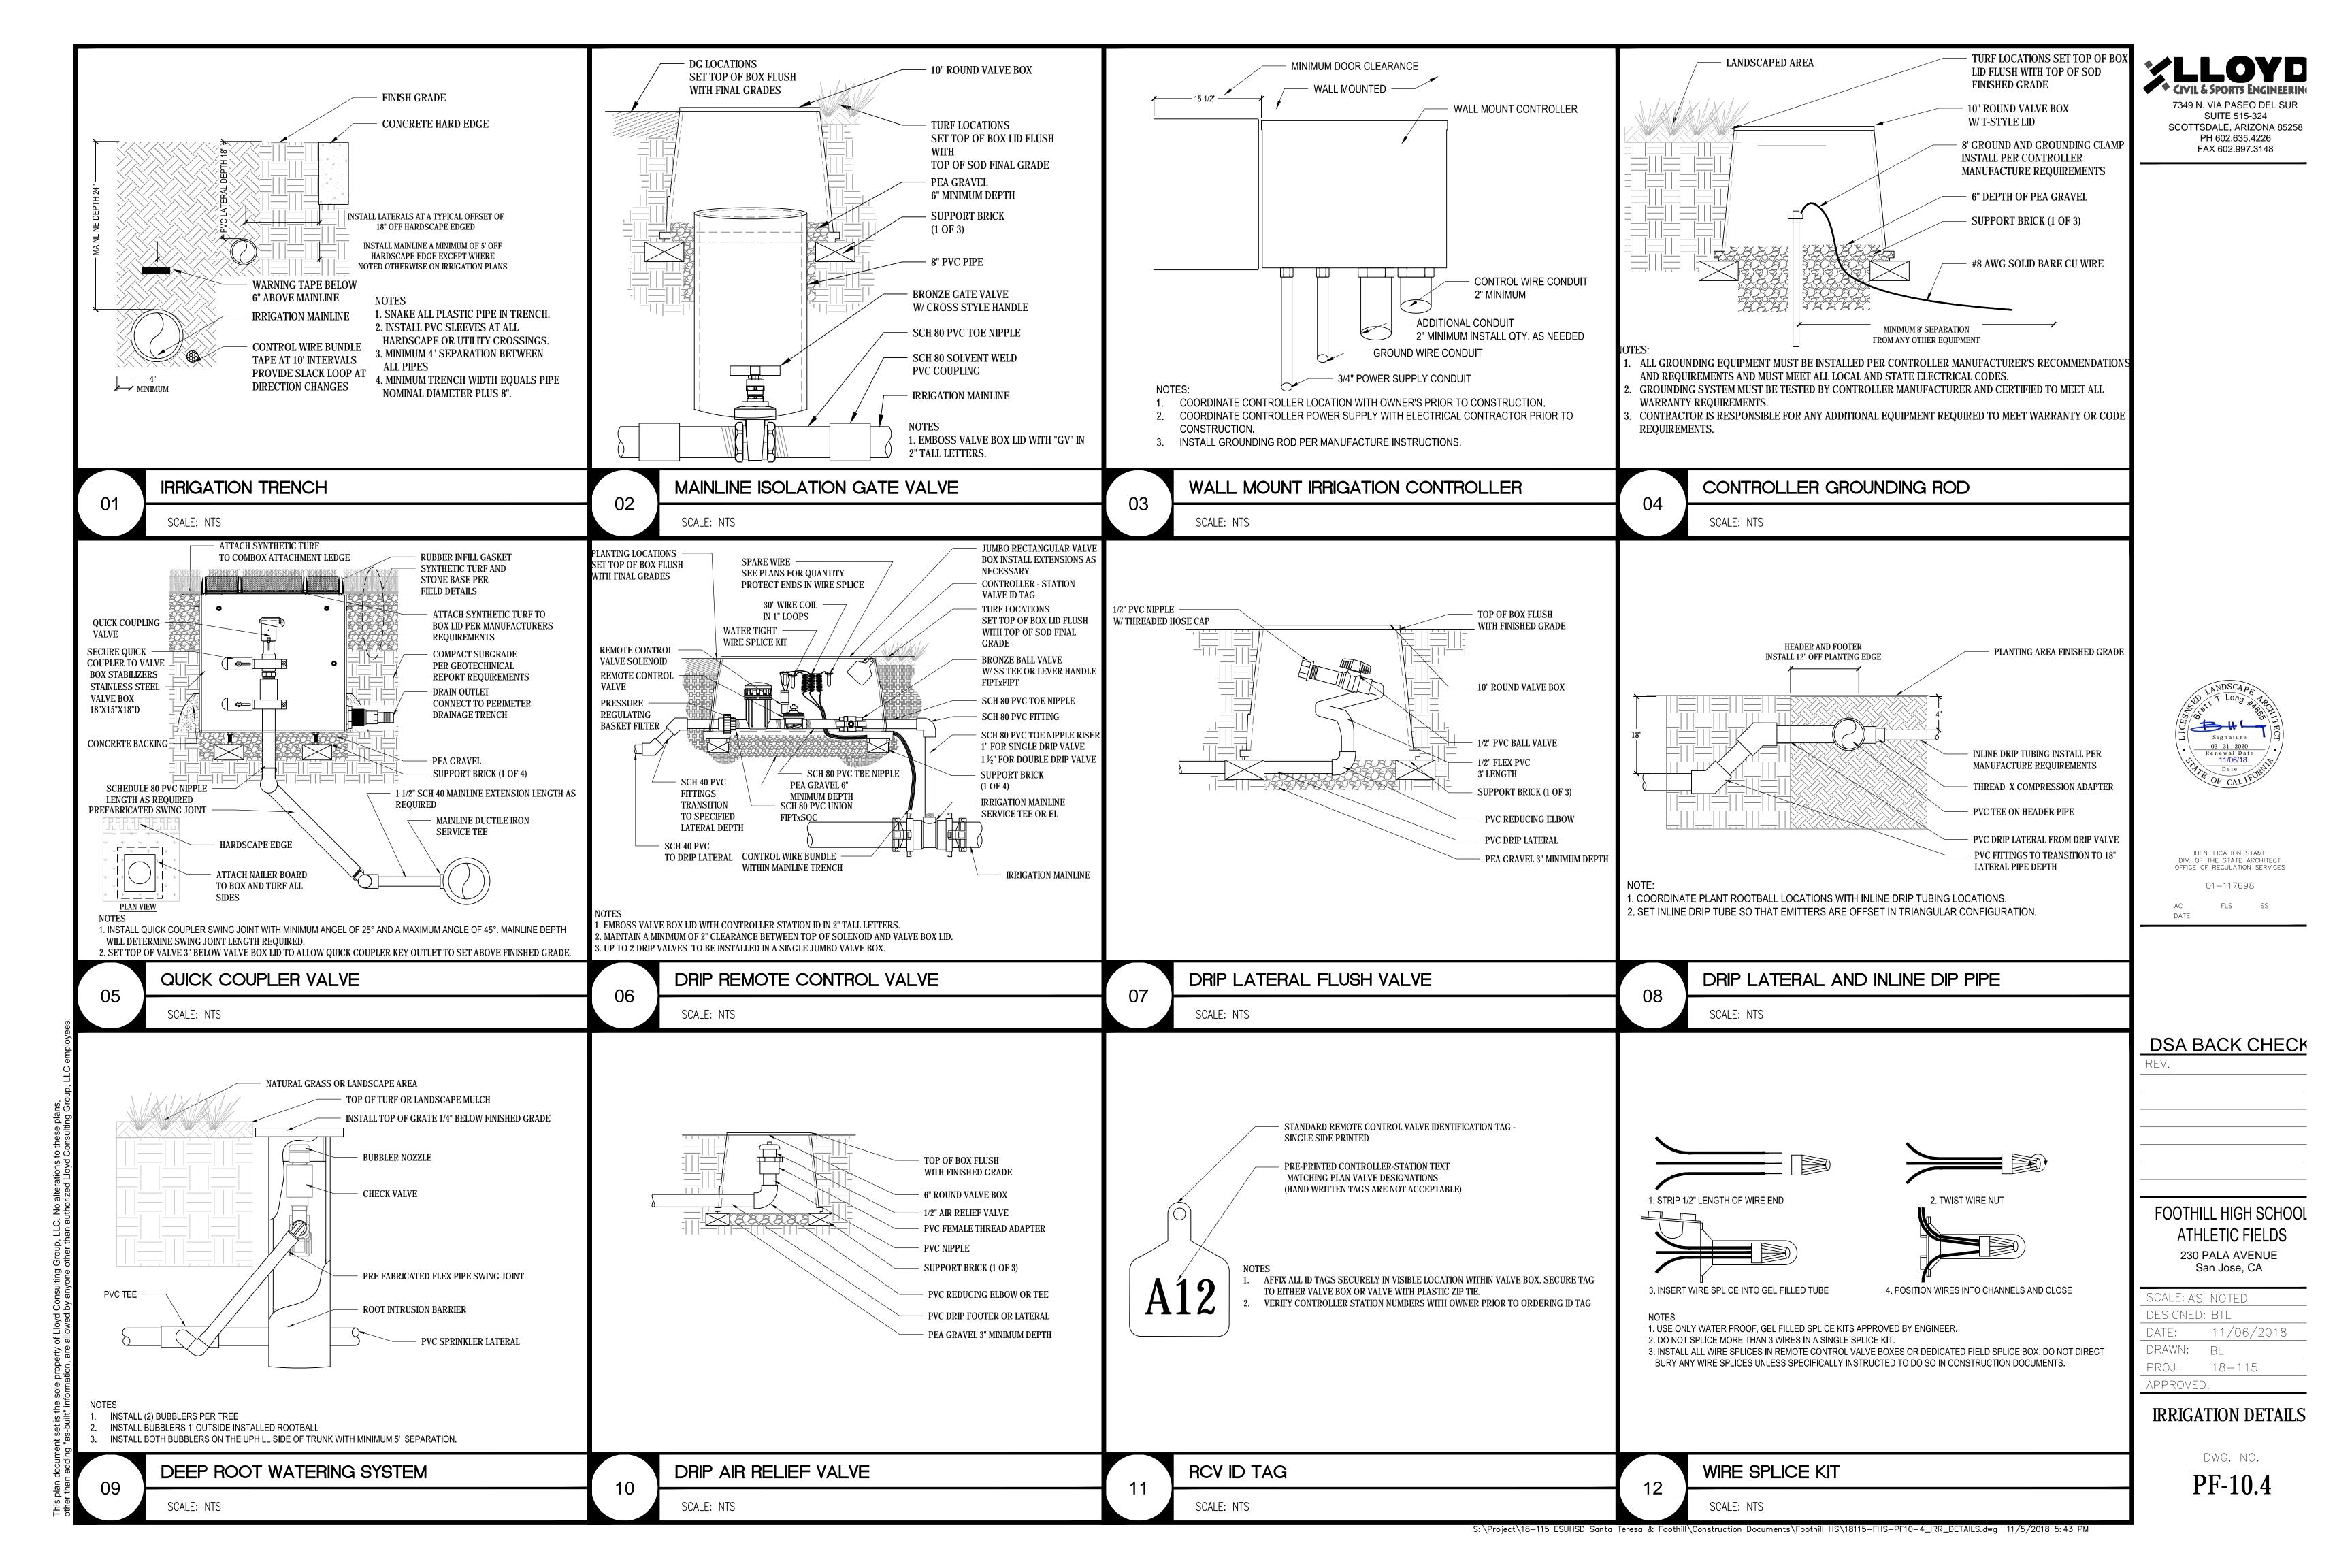

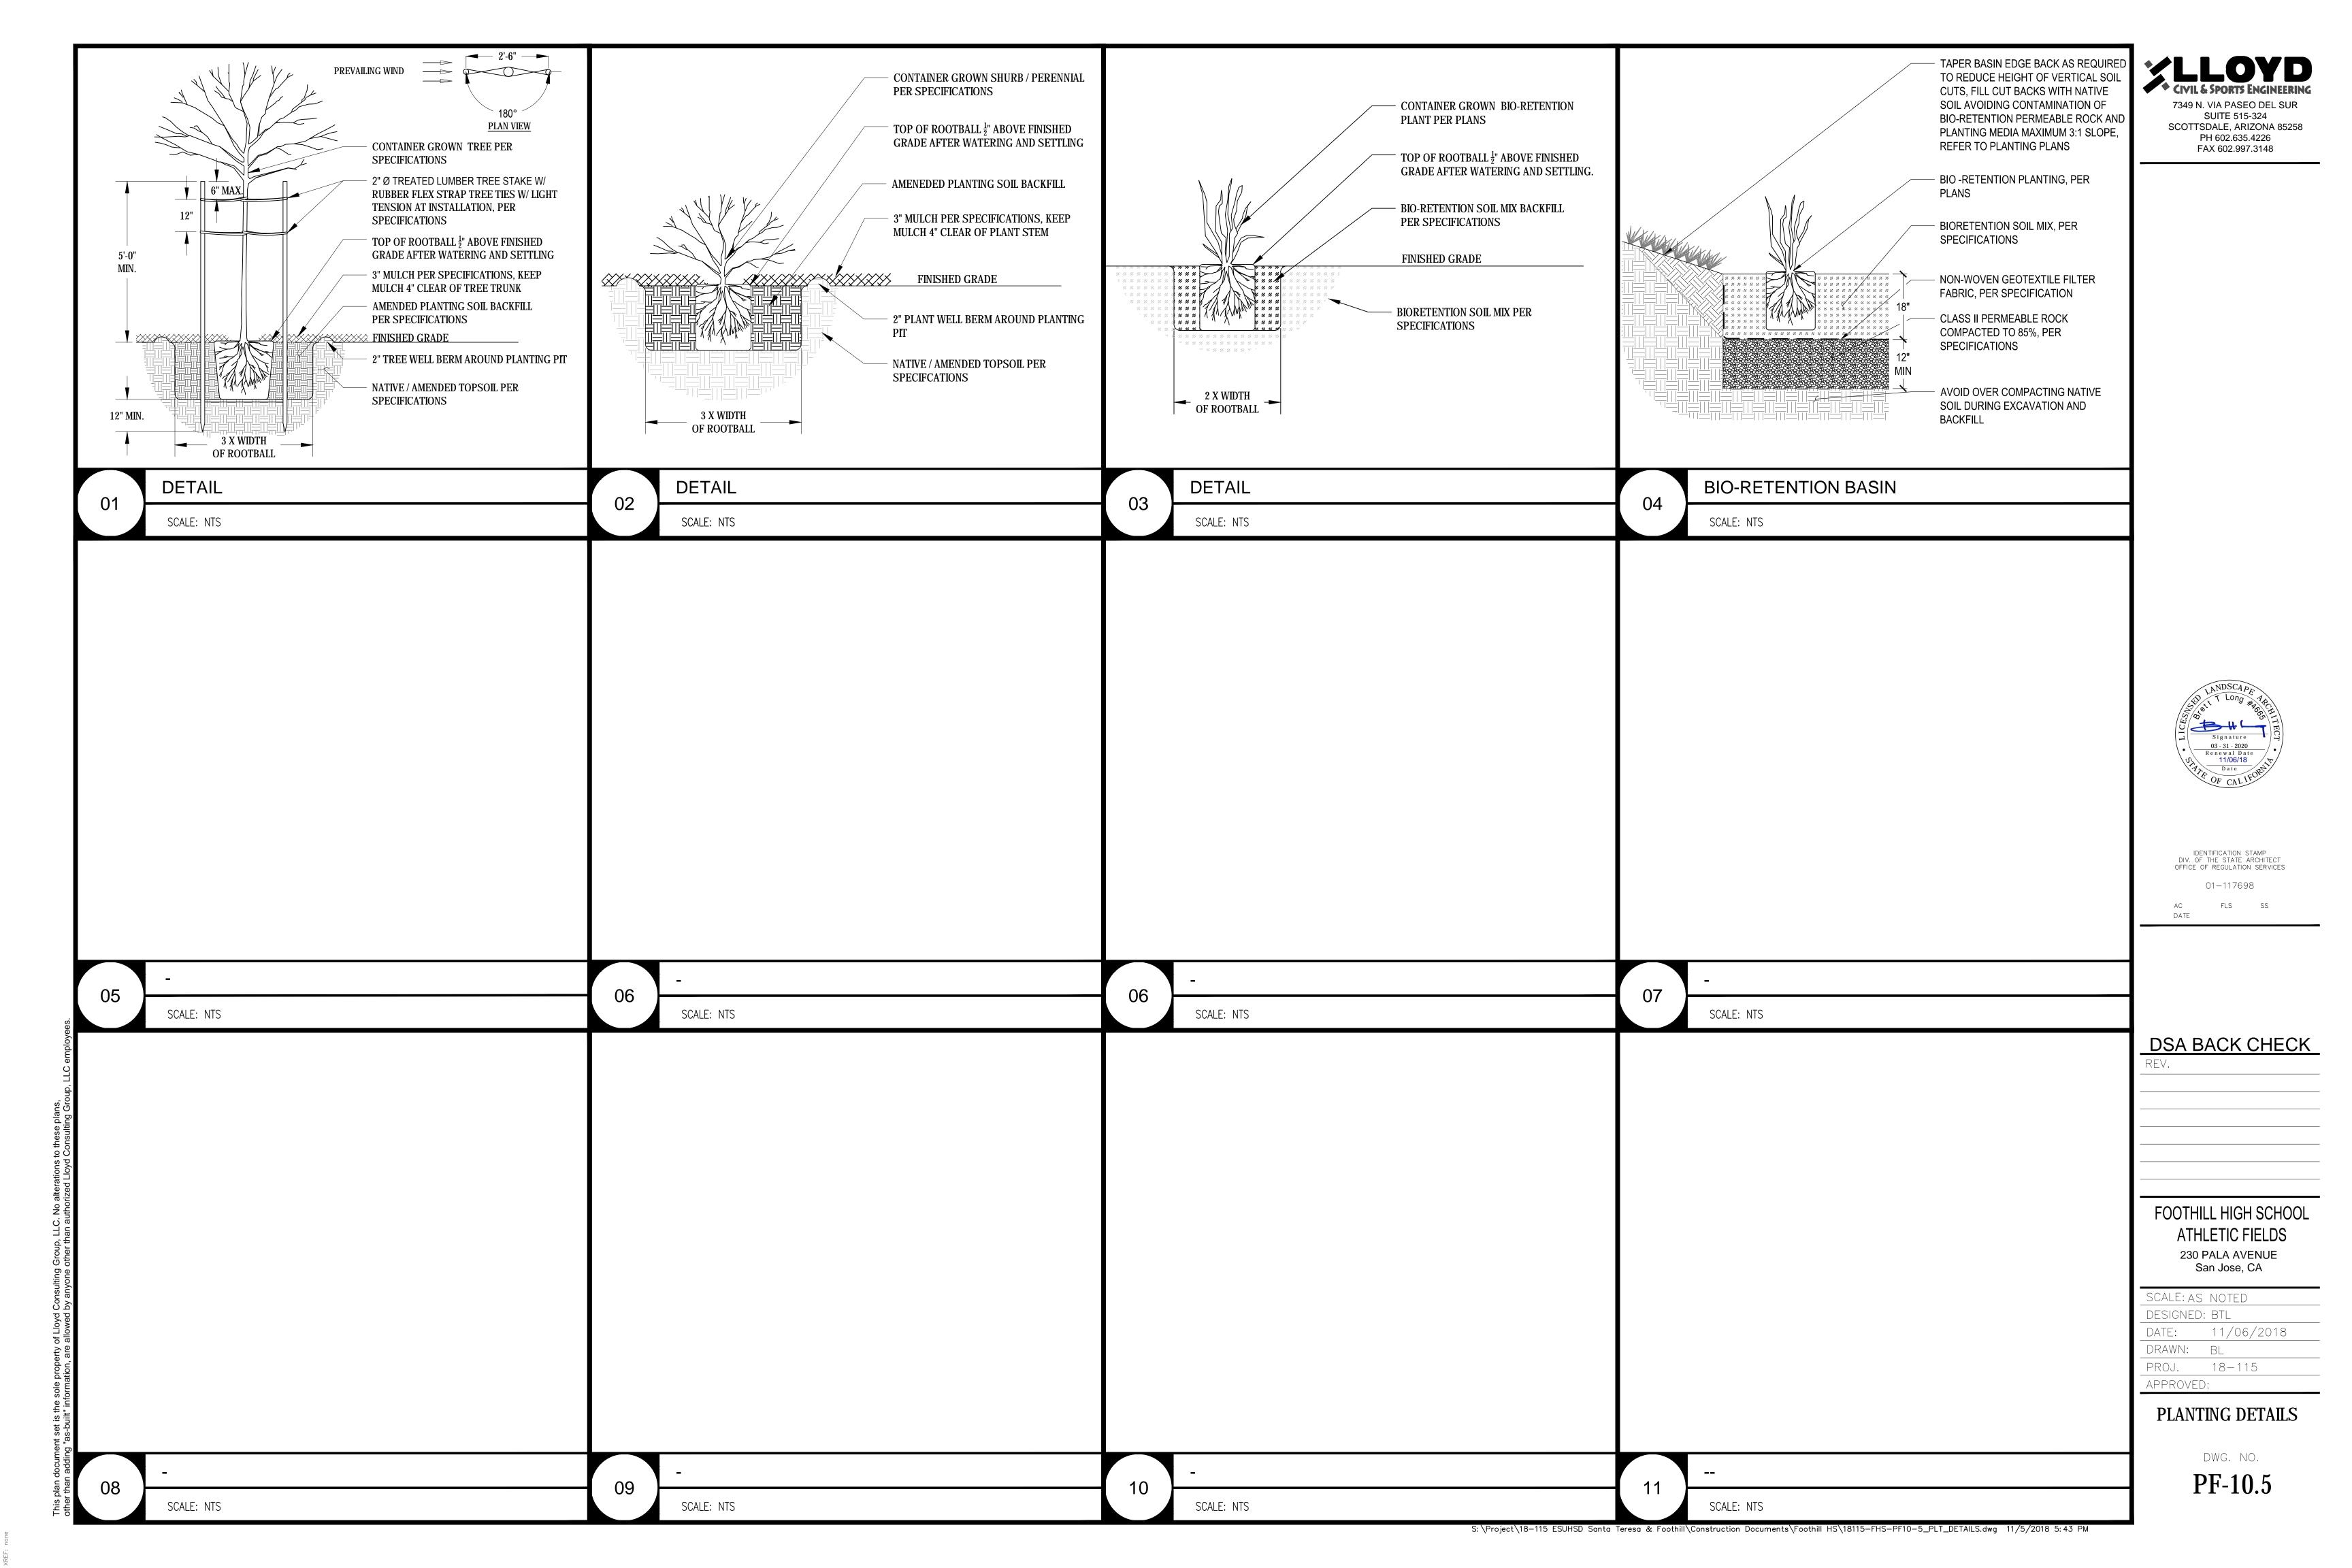





IDENTIFICATION STAMP DIV. OF THE STATE ARCHITECT OFFICE OF REGULATION SERVICES 01-117698 DATE

DSA BACK CHECK

FOOTHILL HIGH SCHOOL ATHLETIC FIELDS 230 PALA AVENUE

San Jose, CA

SCALE: AS NOTED DESIGNED: BTL DATE: 11/06/2018 DRAWN:

PROJ. 18-115 APPROVED:

ACCESS DETAILS

DWG. NO.

PF-10.6

